
PRELIMINARY PLANS


REPLAT OF PART OF PHASE 2


RAVENSWOOD AT HICKORY RIDGE

PLANNED DEVELOPMENT (Z-2439 PDRS TO PDRS)

A PART OF THE SOUTHWEST QUARTER OF SECTION 15, TOWNSHIP 22 NORTH, RANGE 4 WEST, WEA TOWNSHP, TIPPCANOE COUNTY, INDIANA

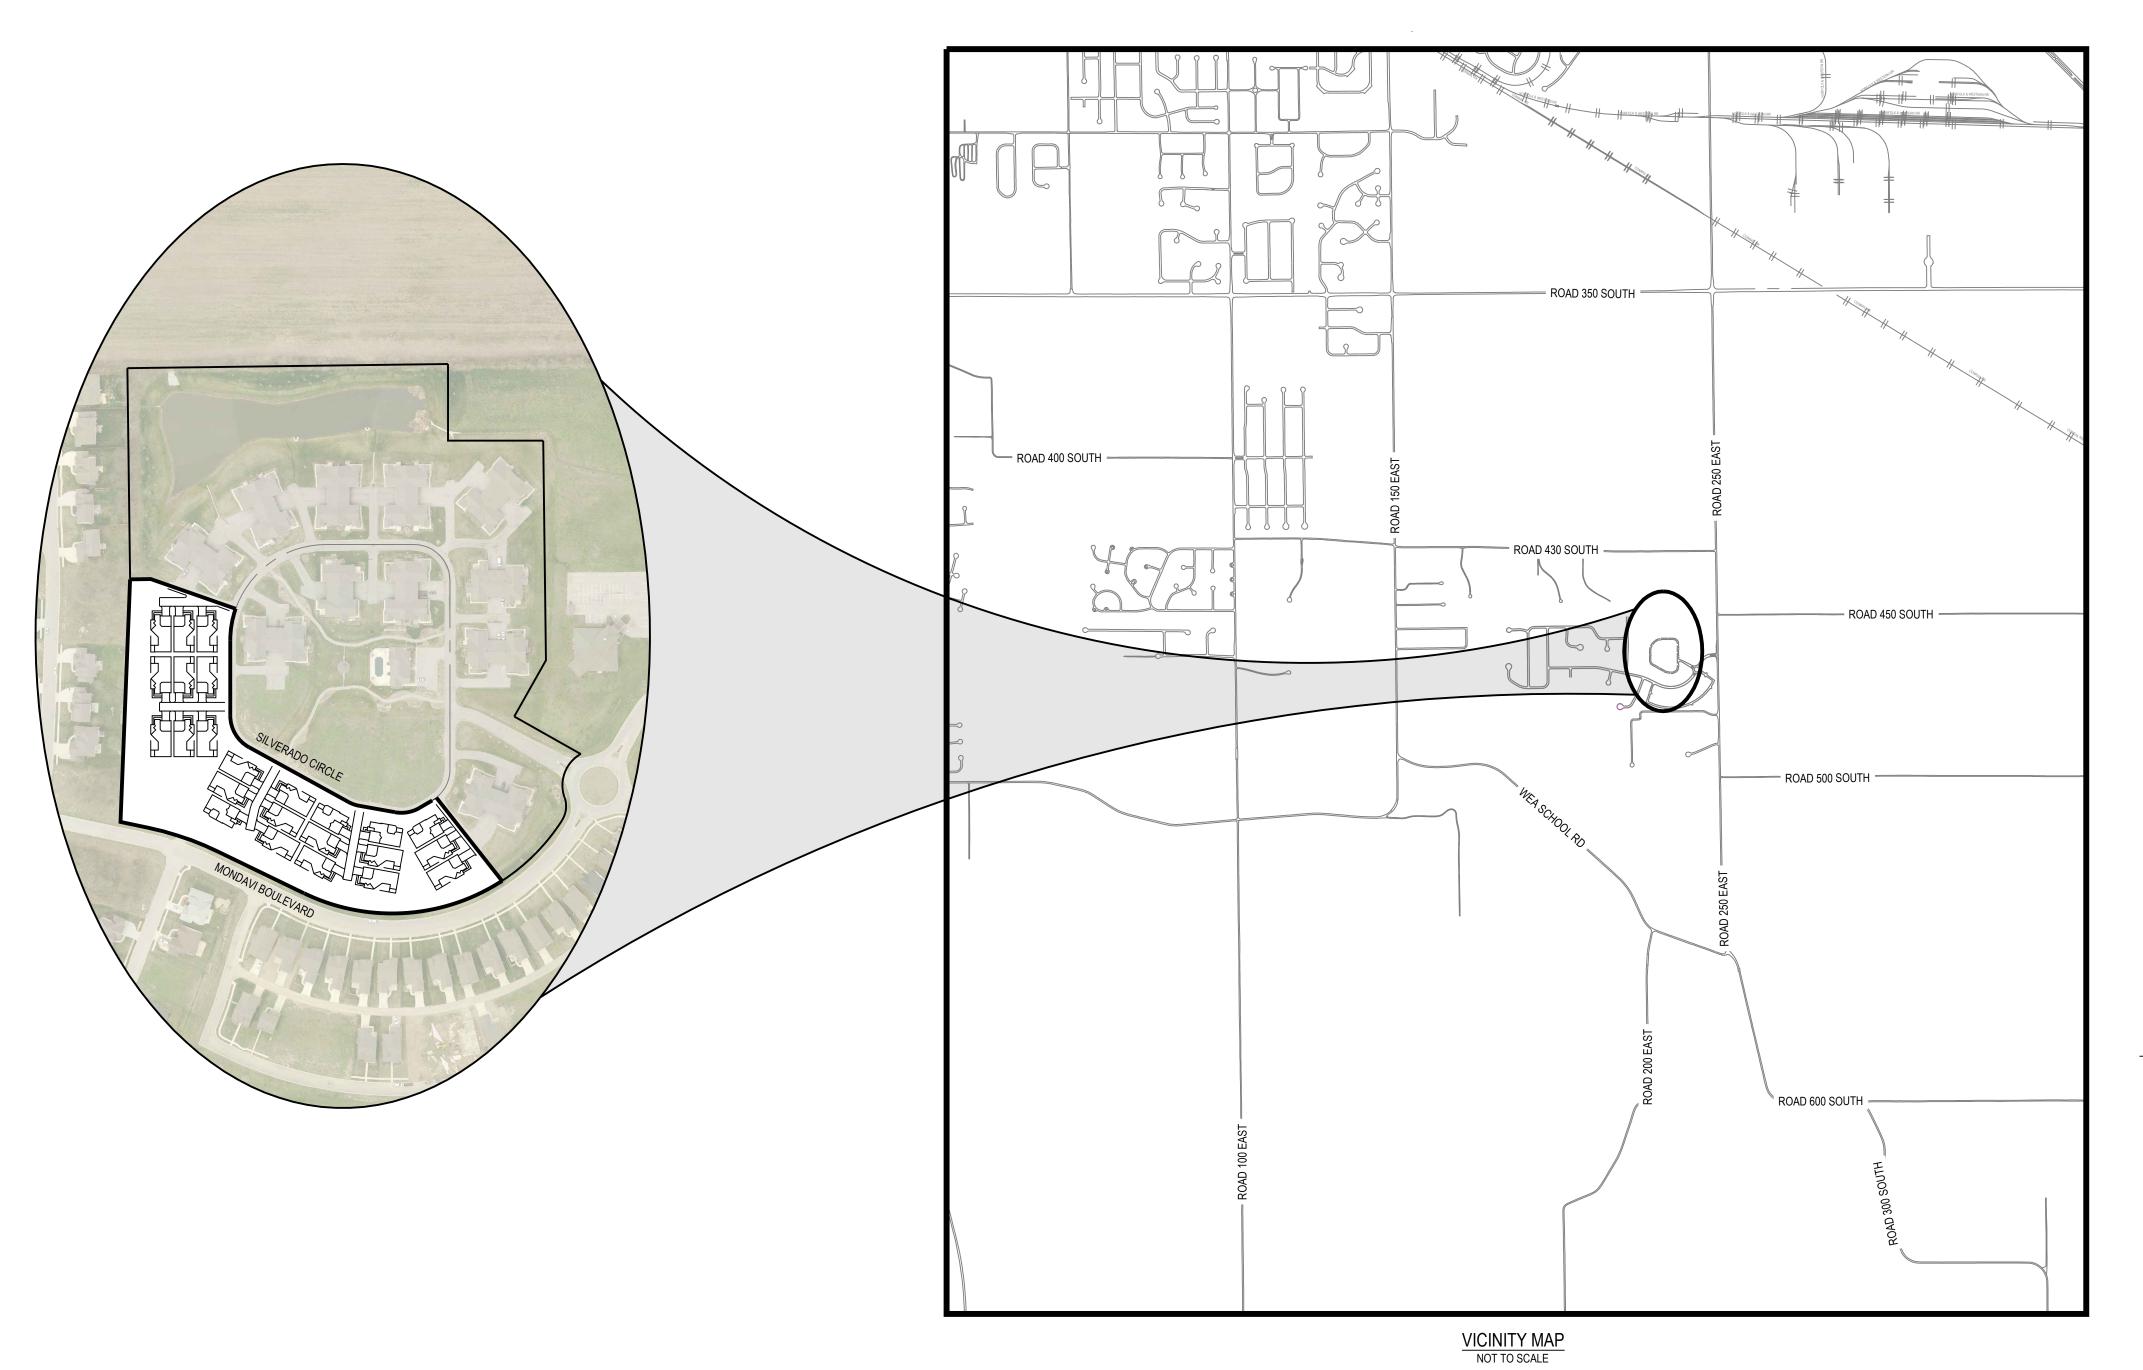

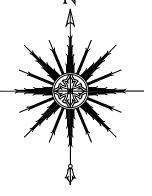

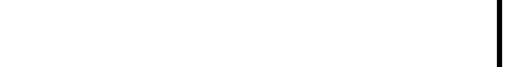

PLANNED DEVELOPMENT SUMMARY

EXISTING SANITARY SEWER AND WATER FACILITIES ARE AVAILABLE ONSITE. THESE UTILITIES ARE AND WILL CONTINUE TO BE PRIVATE.

THE PROPOSED BUILDINGS ARE SINGLE UNIT DETACHED CONDOMINIUM UNITS.

TRASH REMOVAL

TRASH REMOVAL WILL CONTINUE TO BE PROVIDED TO THE RESIDENTS BY PRIVATE CONTRACT WHICH IS ADMINISTERED BY THE HOME OWNERS ASSOCIATION.

MAIL DELIVERY

MAILBOXES WILL BE IN GROUPS OF APPROXIMATELY 8-12 BOXES AND WILL BE LOCATED AT ACCESSIBLE LOCATIONS THROUGHOUT THE DEVELOPMENT.

CONTACT INFORMATION

Lafayette Engineering Department Jennifer Miller, City Engineer Kalan Homes, LLC 4600 Ironstone Lane Lafayette City Engineer's Office Lafayette, IN 47905 20 North 6th Street

Tippecanoe County Area Plan

Tippecanoe County Office Building 20 North 3rd Street Lafayette, IN 47901 765-423-9242

Tippecanoe County Surveyor

Tippecanoe County Office Building

Lafayette, IN 47901 765-423-9228 Engineer/Surveyor

20 North Third Street

TBIRD Design Services Corporation Lafayette, IN 47901 Phone: 765-742-1900 Fax: 765-742-1905

765-807-1800 **Lafayette Waterworks Department**

Lafayette Water Pollution Control

Kerry Smith, Department Head 20 North 6th Street Lafayette, IN 47901 765-807-1700

Lafayette, Indiana 47901

765-807-1050

Brad Talley

1700 Wabash Avenue

Lafayette, IN 47905

SHEET INDEX ZONING EXISTING FINAL PLAT (REFERENCE) PRELIMINARY PLAT SITE & UTILITY PLAN OVERALL LANDSCAPE PLAN DETAILED LANDSCAPE PLAN TYPICAL BUILDING PLANS



10076-GENERAL.DV DRAWN BY: CHECKED BY:

LOCATION: A PART OF THE SOUTHWEST QUARTER

OF SECTION 15, TOWNSHIP 22 NORTH RANGE 4 WEST, WEA TOWNSHIP, TIPPECANOE COUNTY, INDIANA

TITLE SHEET

COUNTY ROAD 430 SOUTH CERTIFIED BY: PDRS BENJAMIN CROSSING

CURRENT ZONE: PDRS

CURRENT USE: SINGLE FAMILY RESIDENTIAL CURRENT ZONE: R1
CURRENT USE: AGRICULTURAL **COUNTY ROAD 450 SOUTH** PDRS

RAVENSWOOD

CURRENT ZONE: PDRS (Z-2151)

CURRENT USE: RESIDENTIAL CONDOMINIUMS PDRS CURRENT ZONE: PDRS (Z-2151) CURRENT USE: CHURCH R1B AVALON BLUFF

CURRENT ZONE: R1B


CURRENT USE: SINGLE FAMILY RESIDENTIAL PROPOSED PLANNED DEVELOPMENT
PROPOSED ZONE: PDRS
PROPOSED USE: RESIDENTIAL CONDOMINIUMS HICKORY RIDGE


CURRENT ZONE: R1


CURRENT USE: SINGLE FAMILY RESIDENTIAL THE RETREAT


CURRENT ZONE: PDRS (Z-2152)


CURRENT USE: SINGLE FAMILY RESIDENTIAL R1 CURRENT ZONE: R1
CURRENT USE: SINGLE FAMILY RESIDENTIAL PROJECT NO: 10076-ZONING.DWG DRAWN BY: CHECKED BY: LOCATION: A PART OF THE SOUTHWEST QUARTER OF SECTION 15, TOWNSHIP 22 NORTH, RANGE 4 WEST, WEA TOWNSHIP, TIPPECANOE COUNTY, INDIANA HORIZONTAL SCALE: 1" = 200' **LEGEND** ZONING = ZONING BOUNDARY

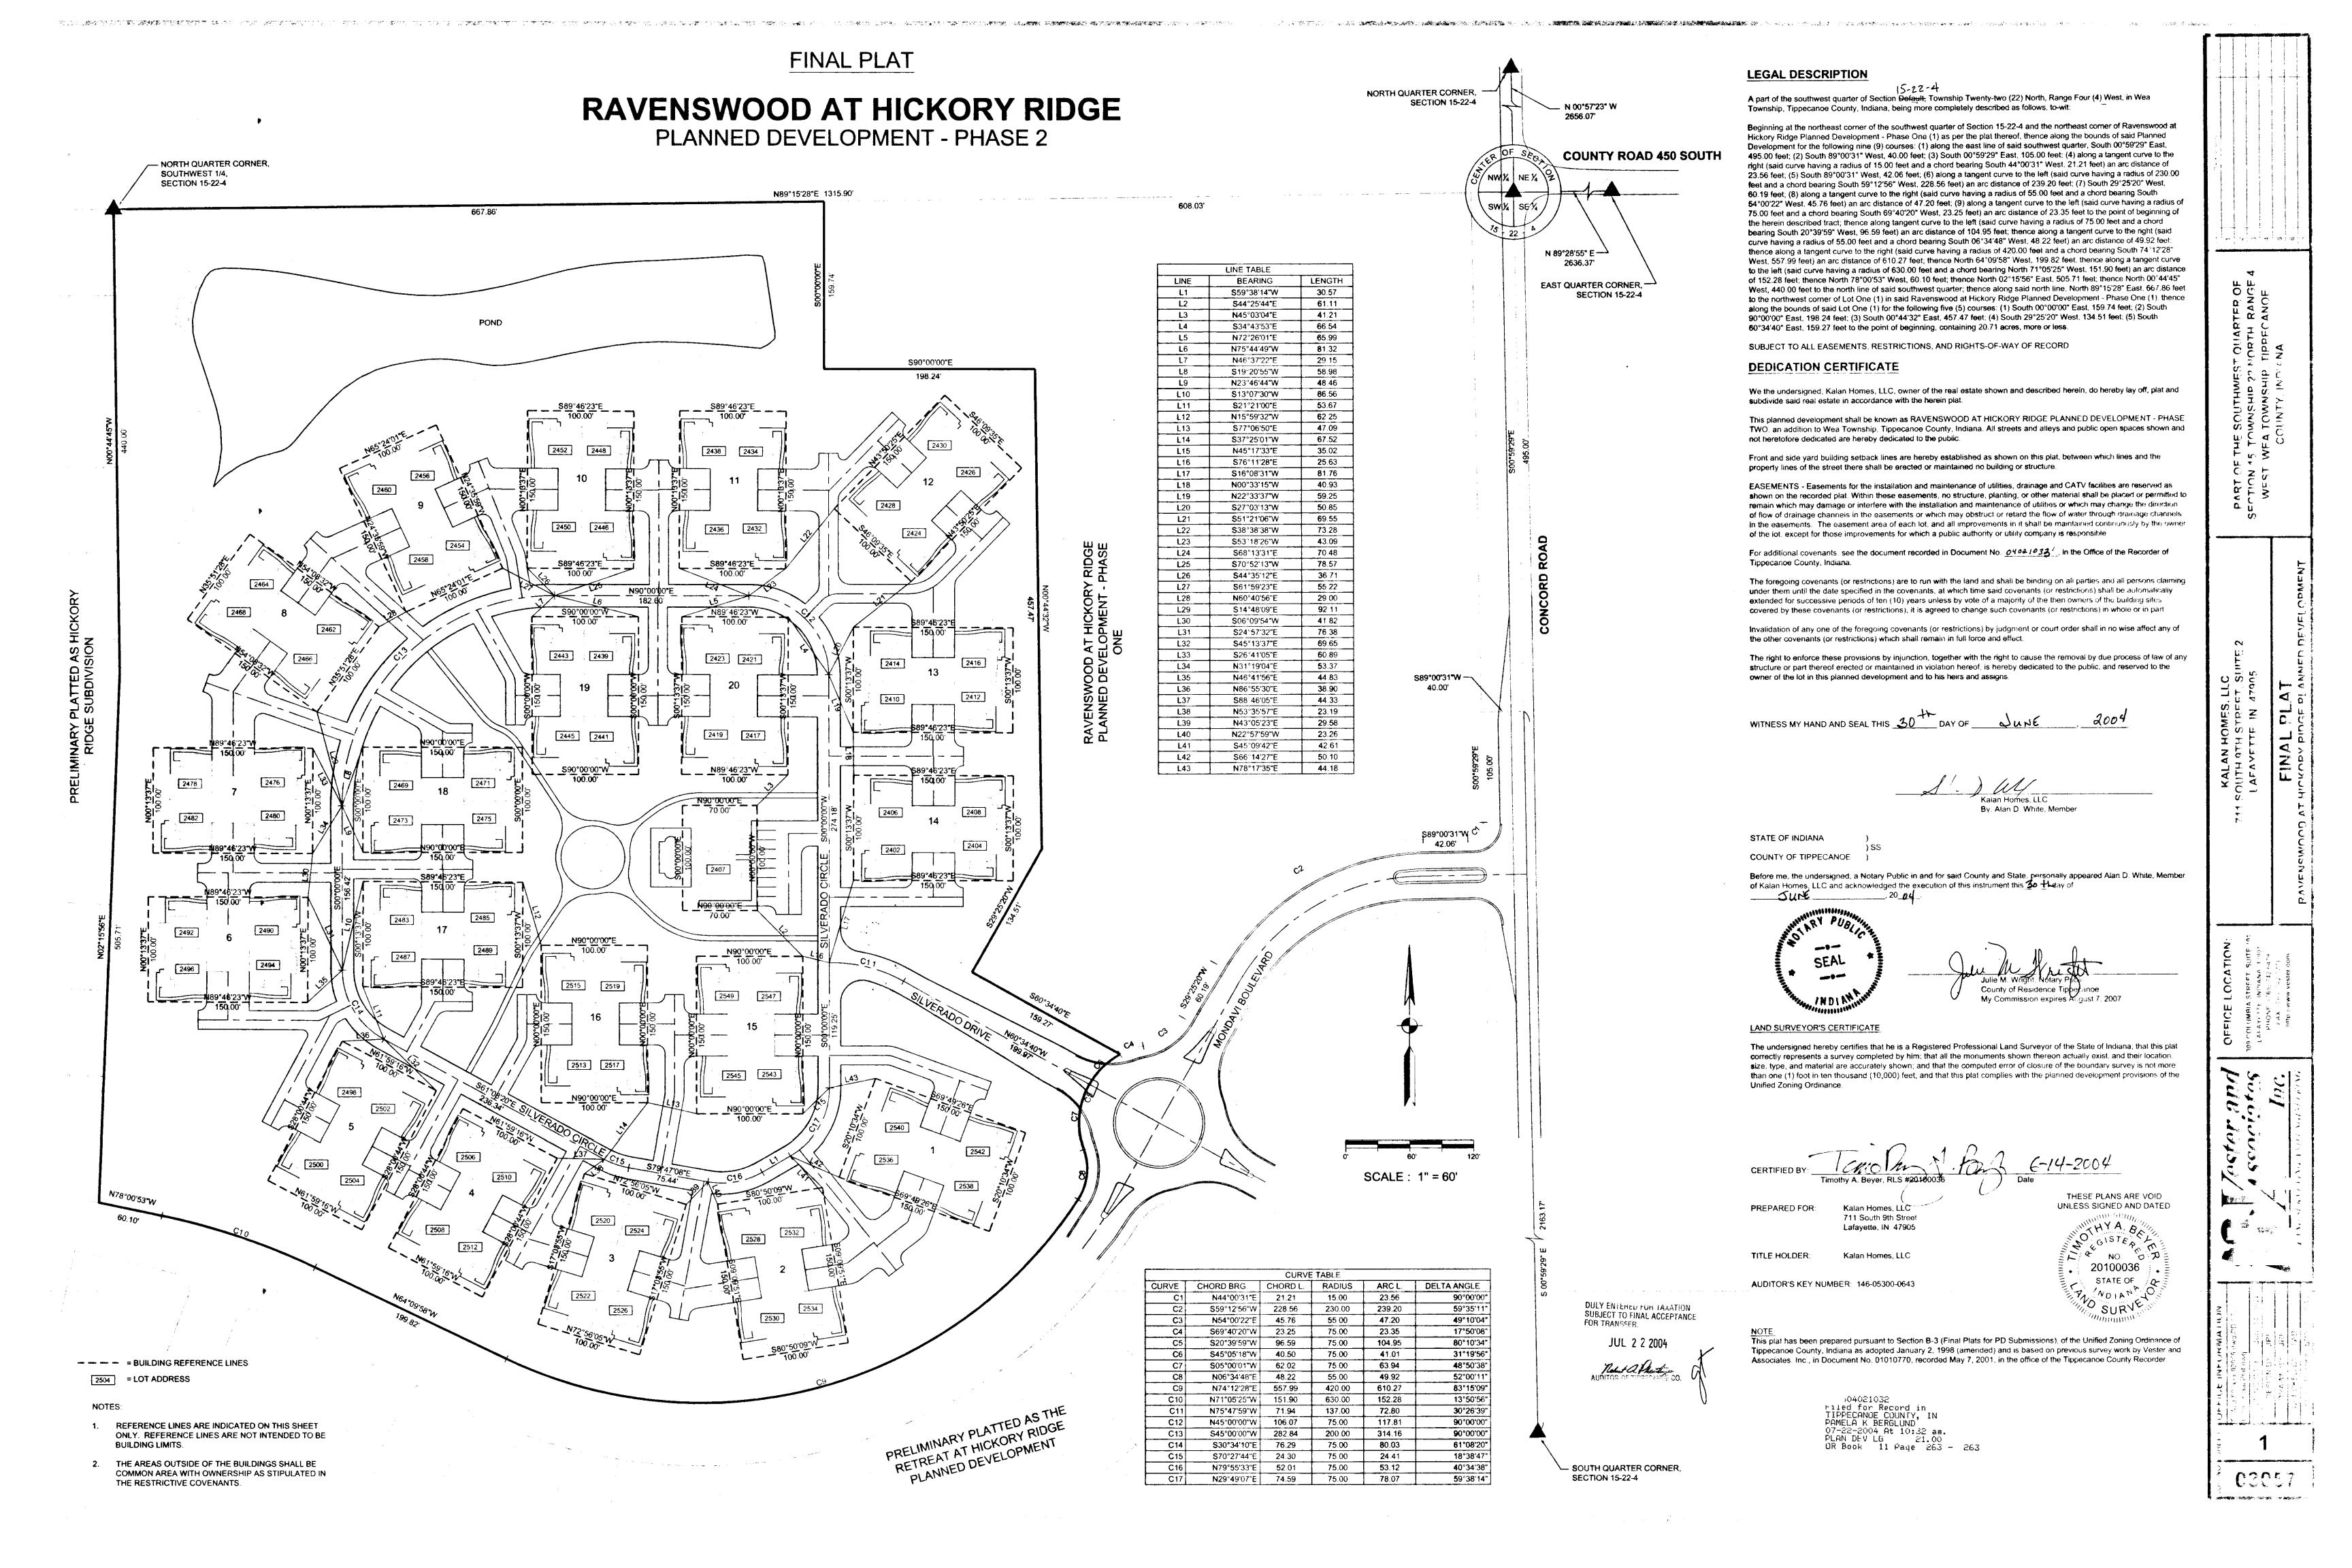

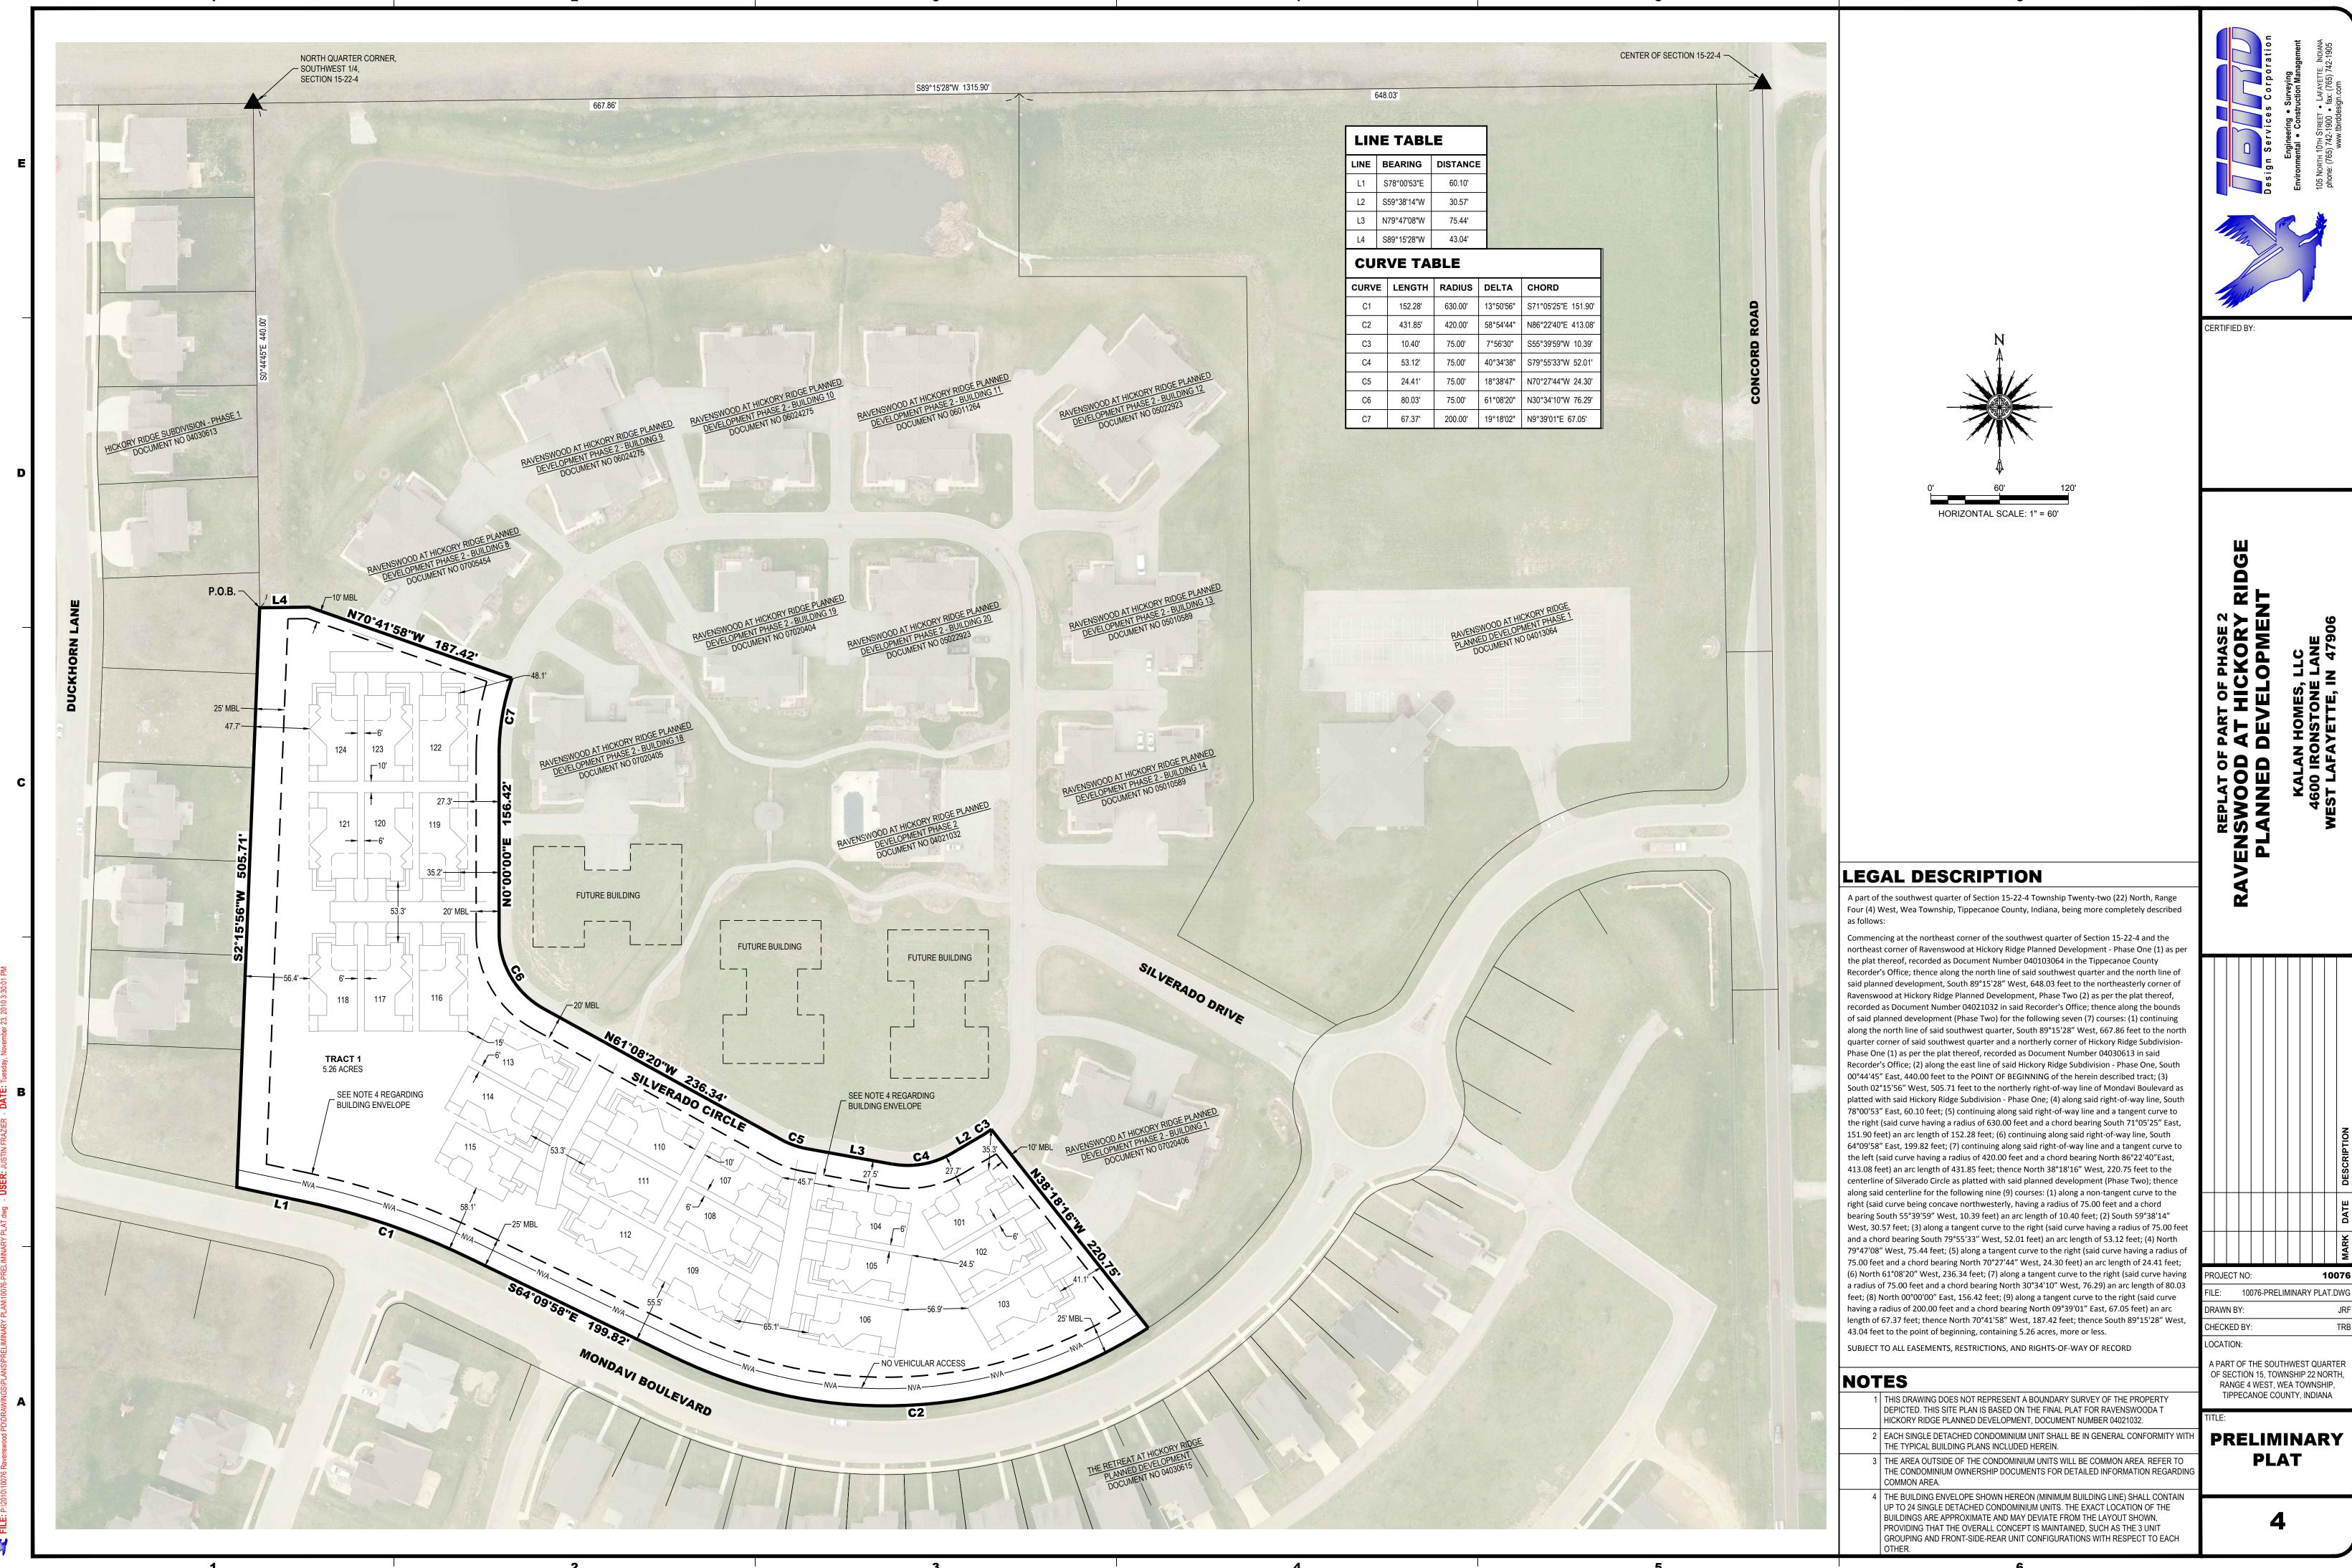


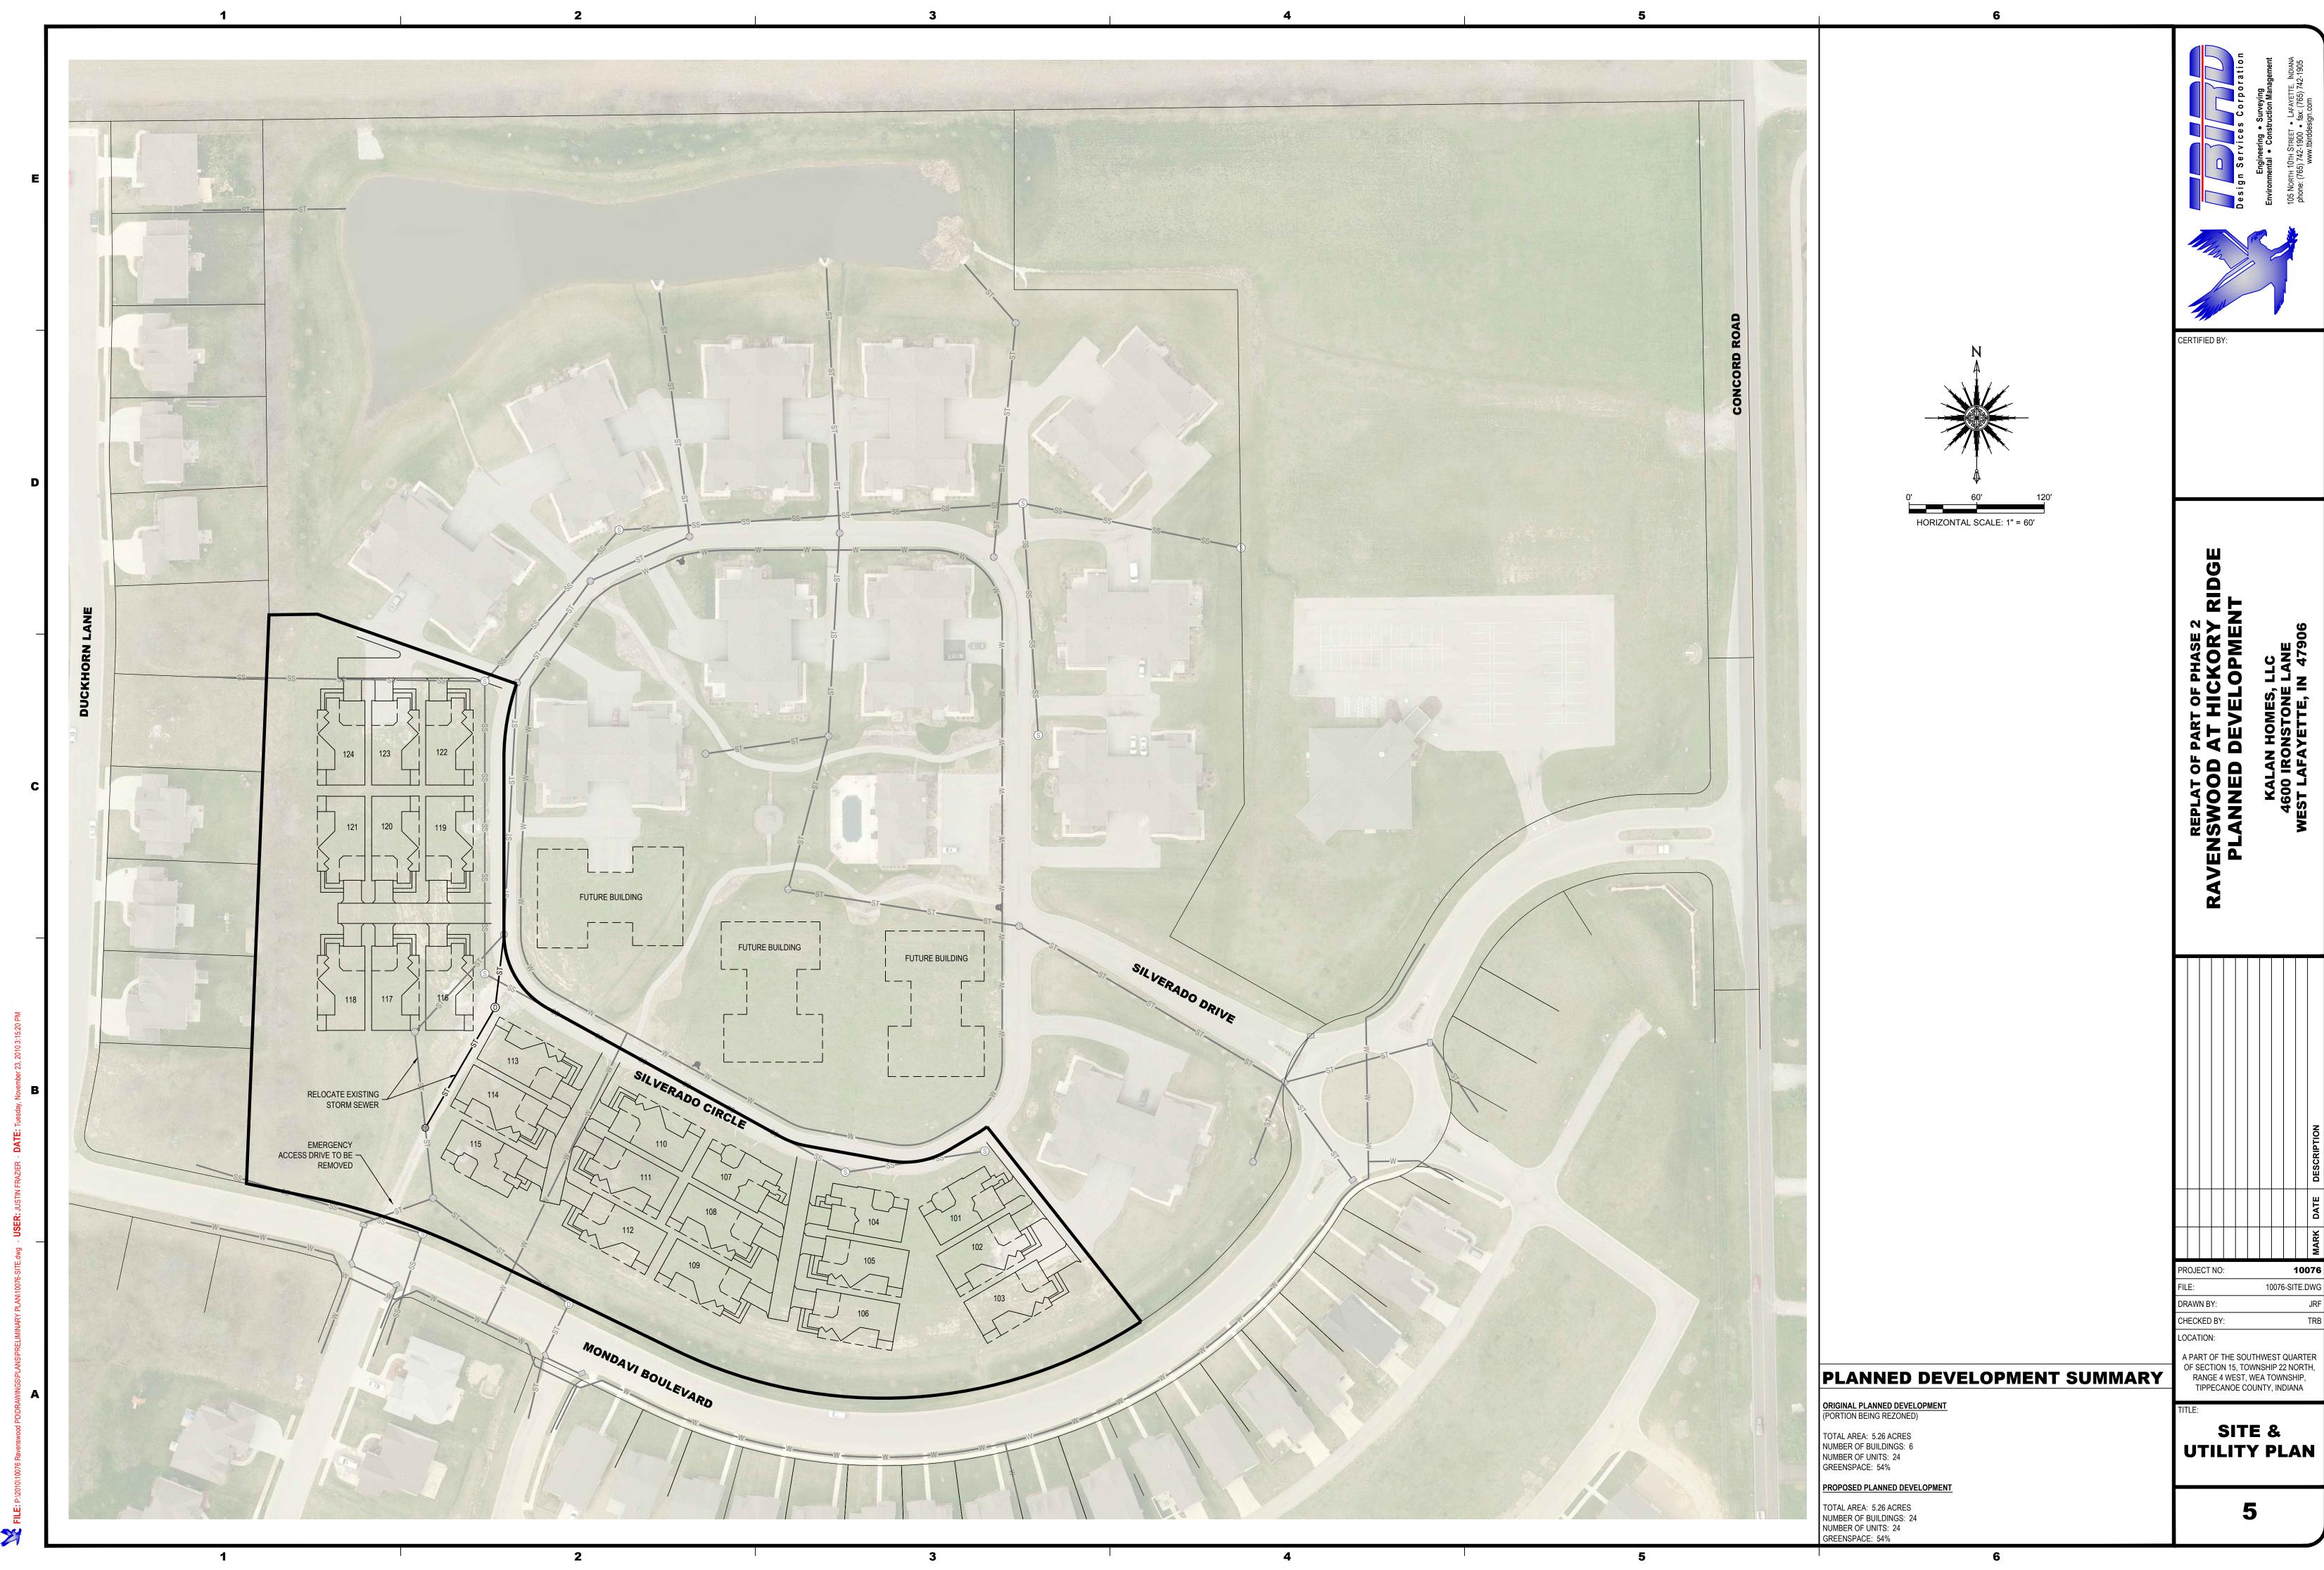


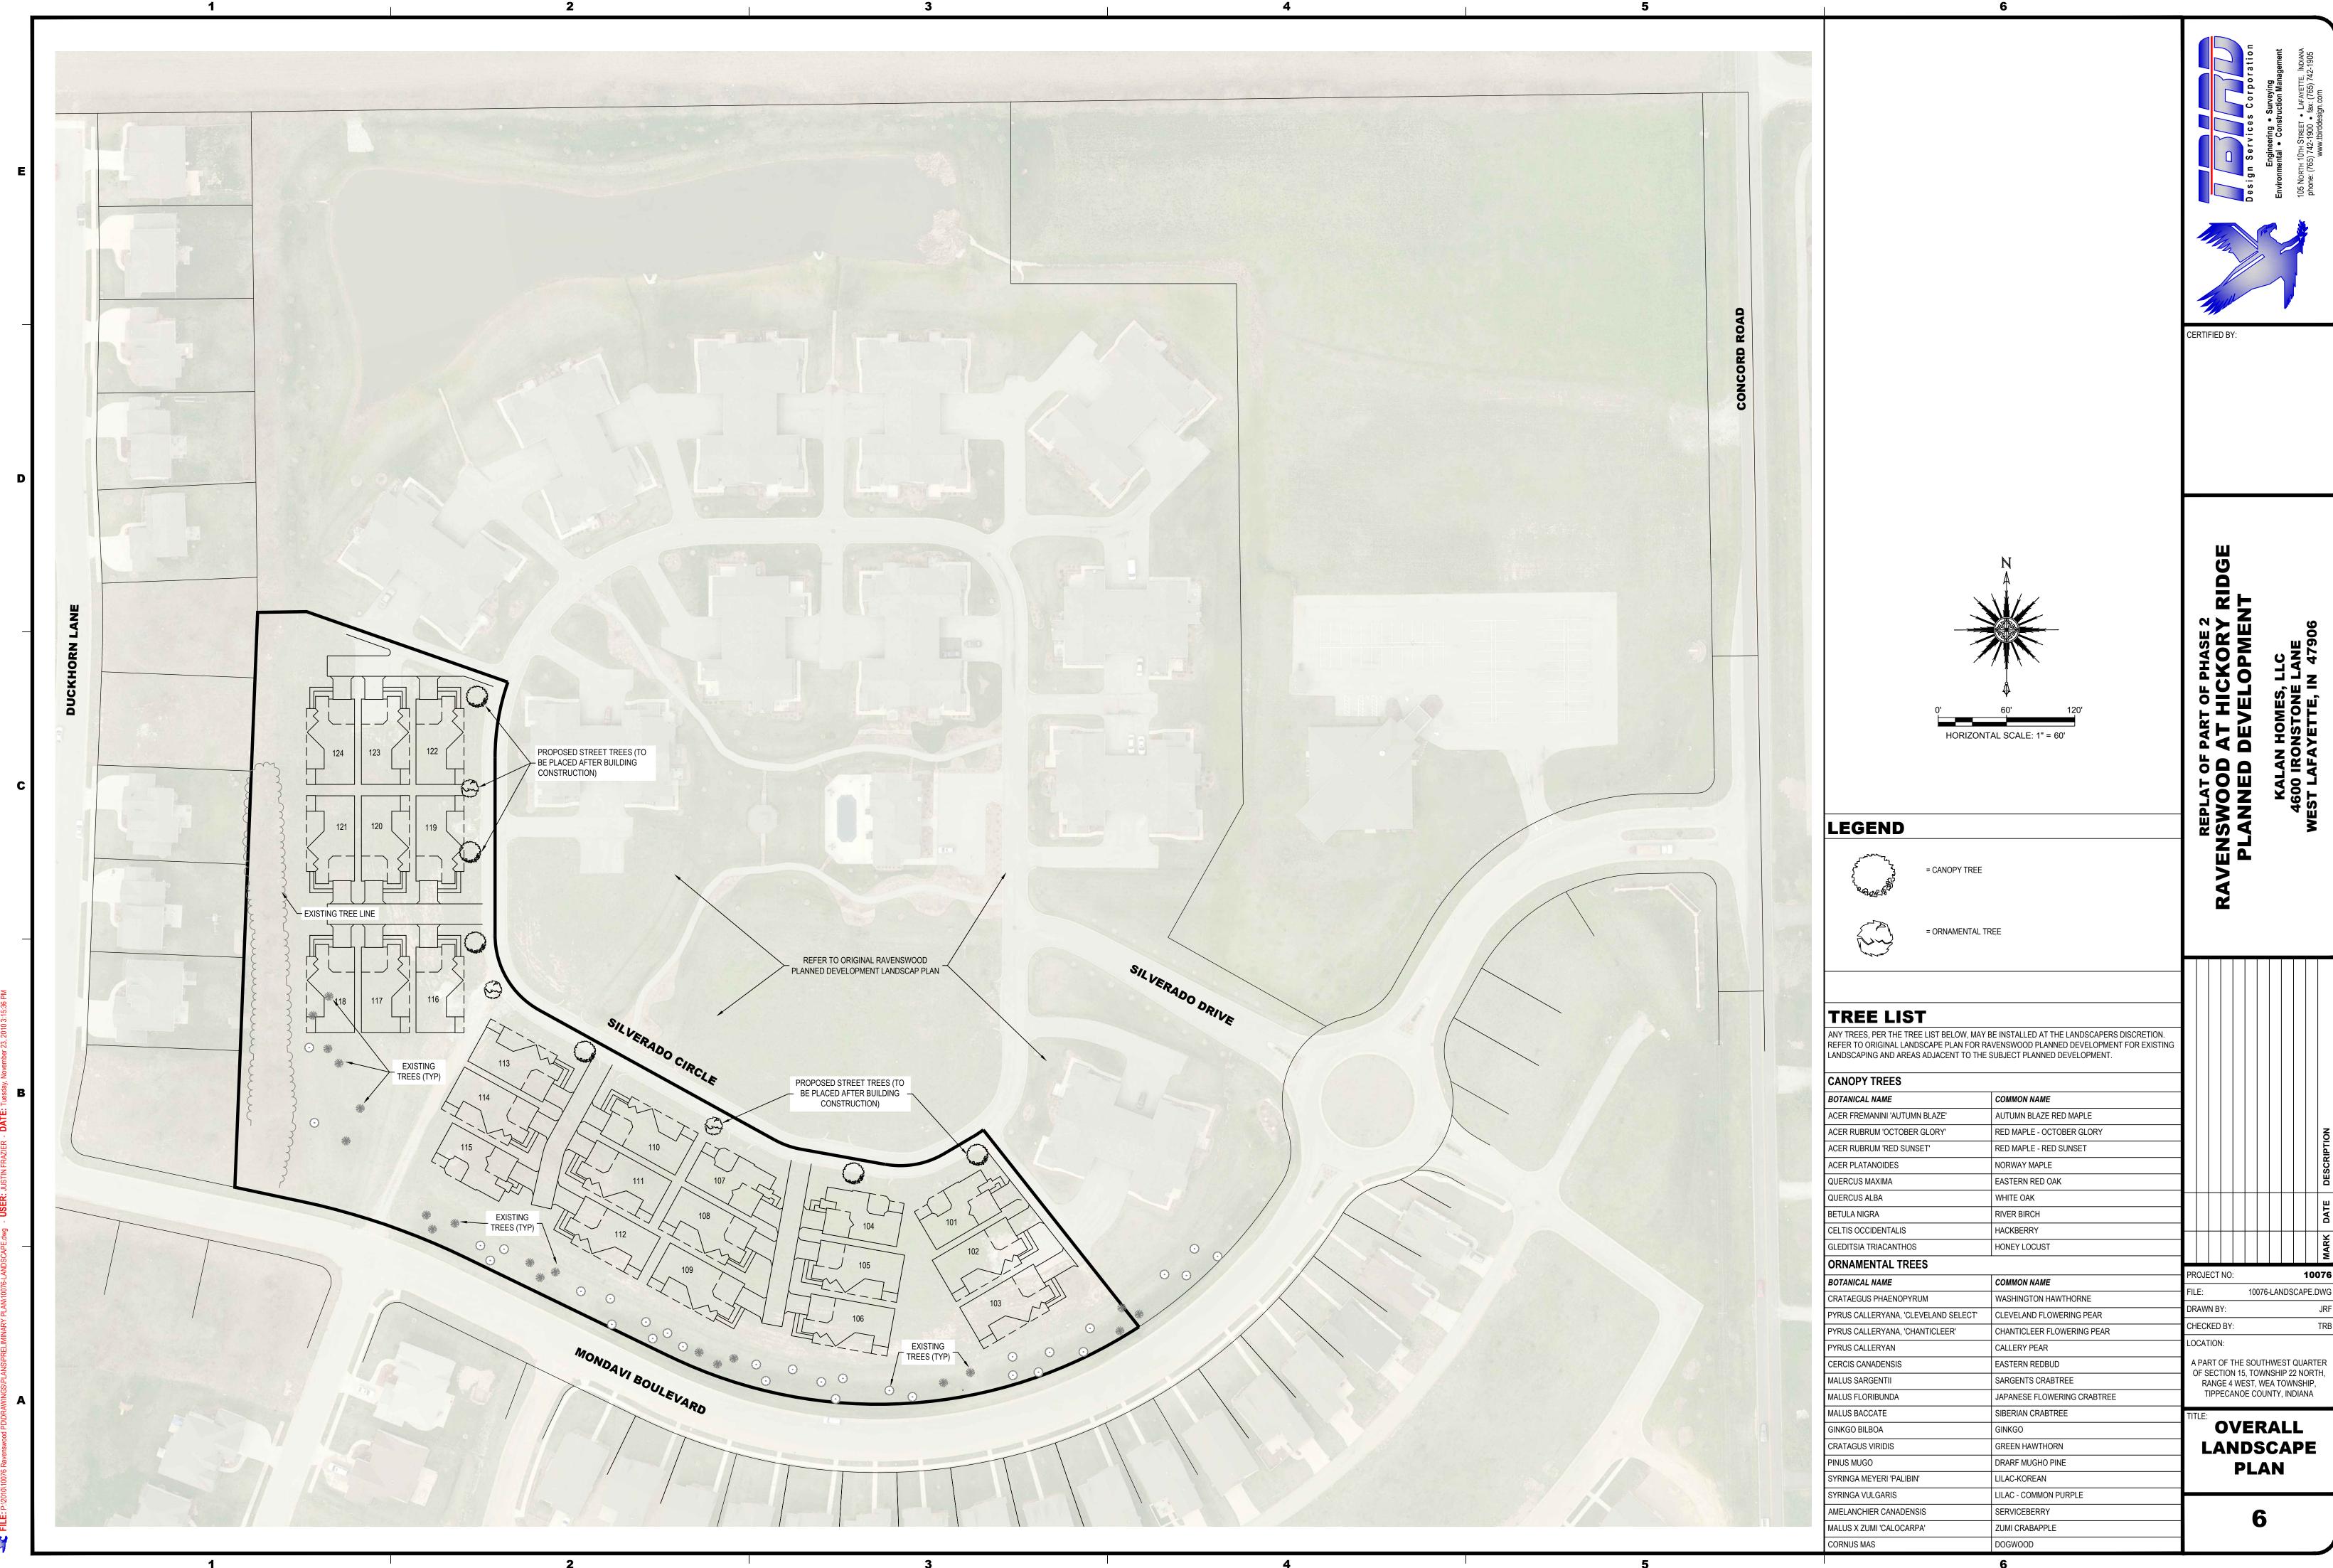

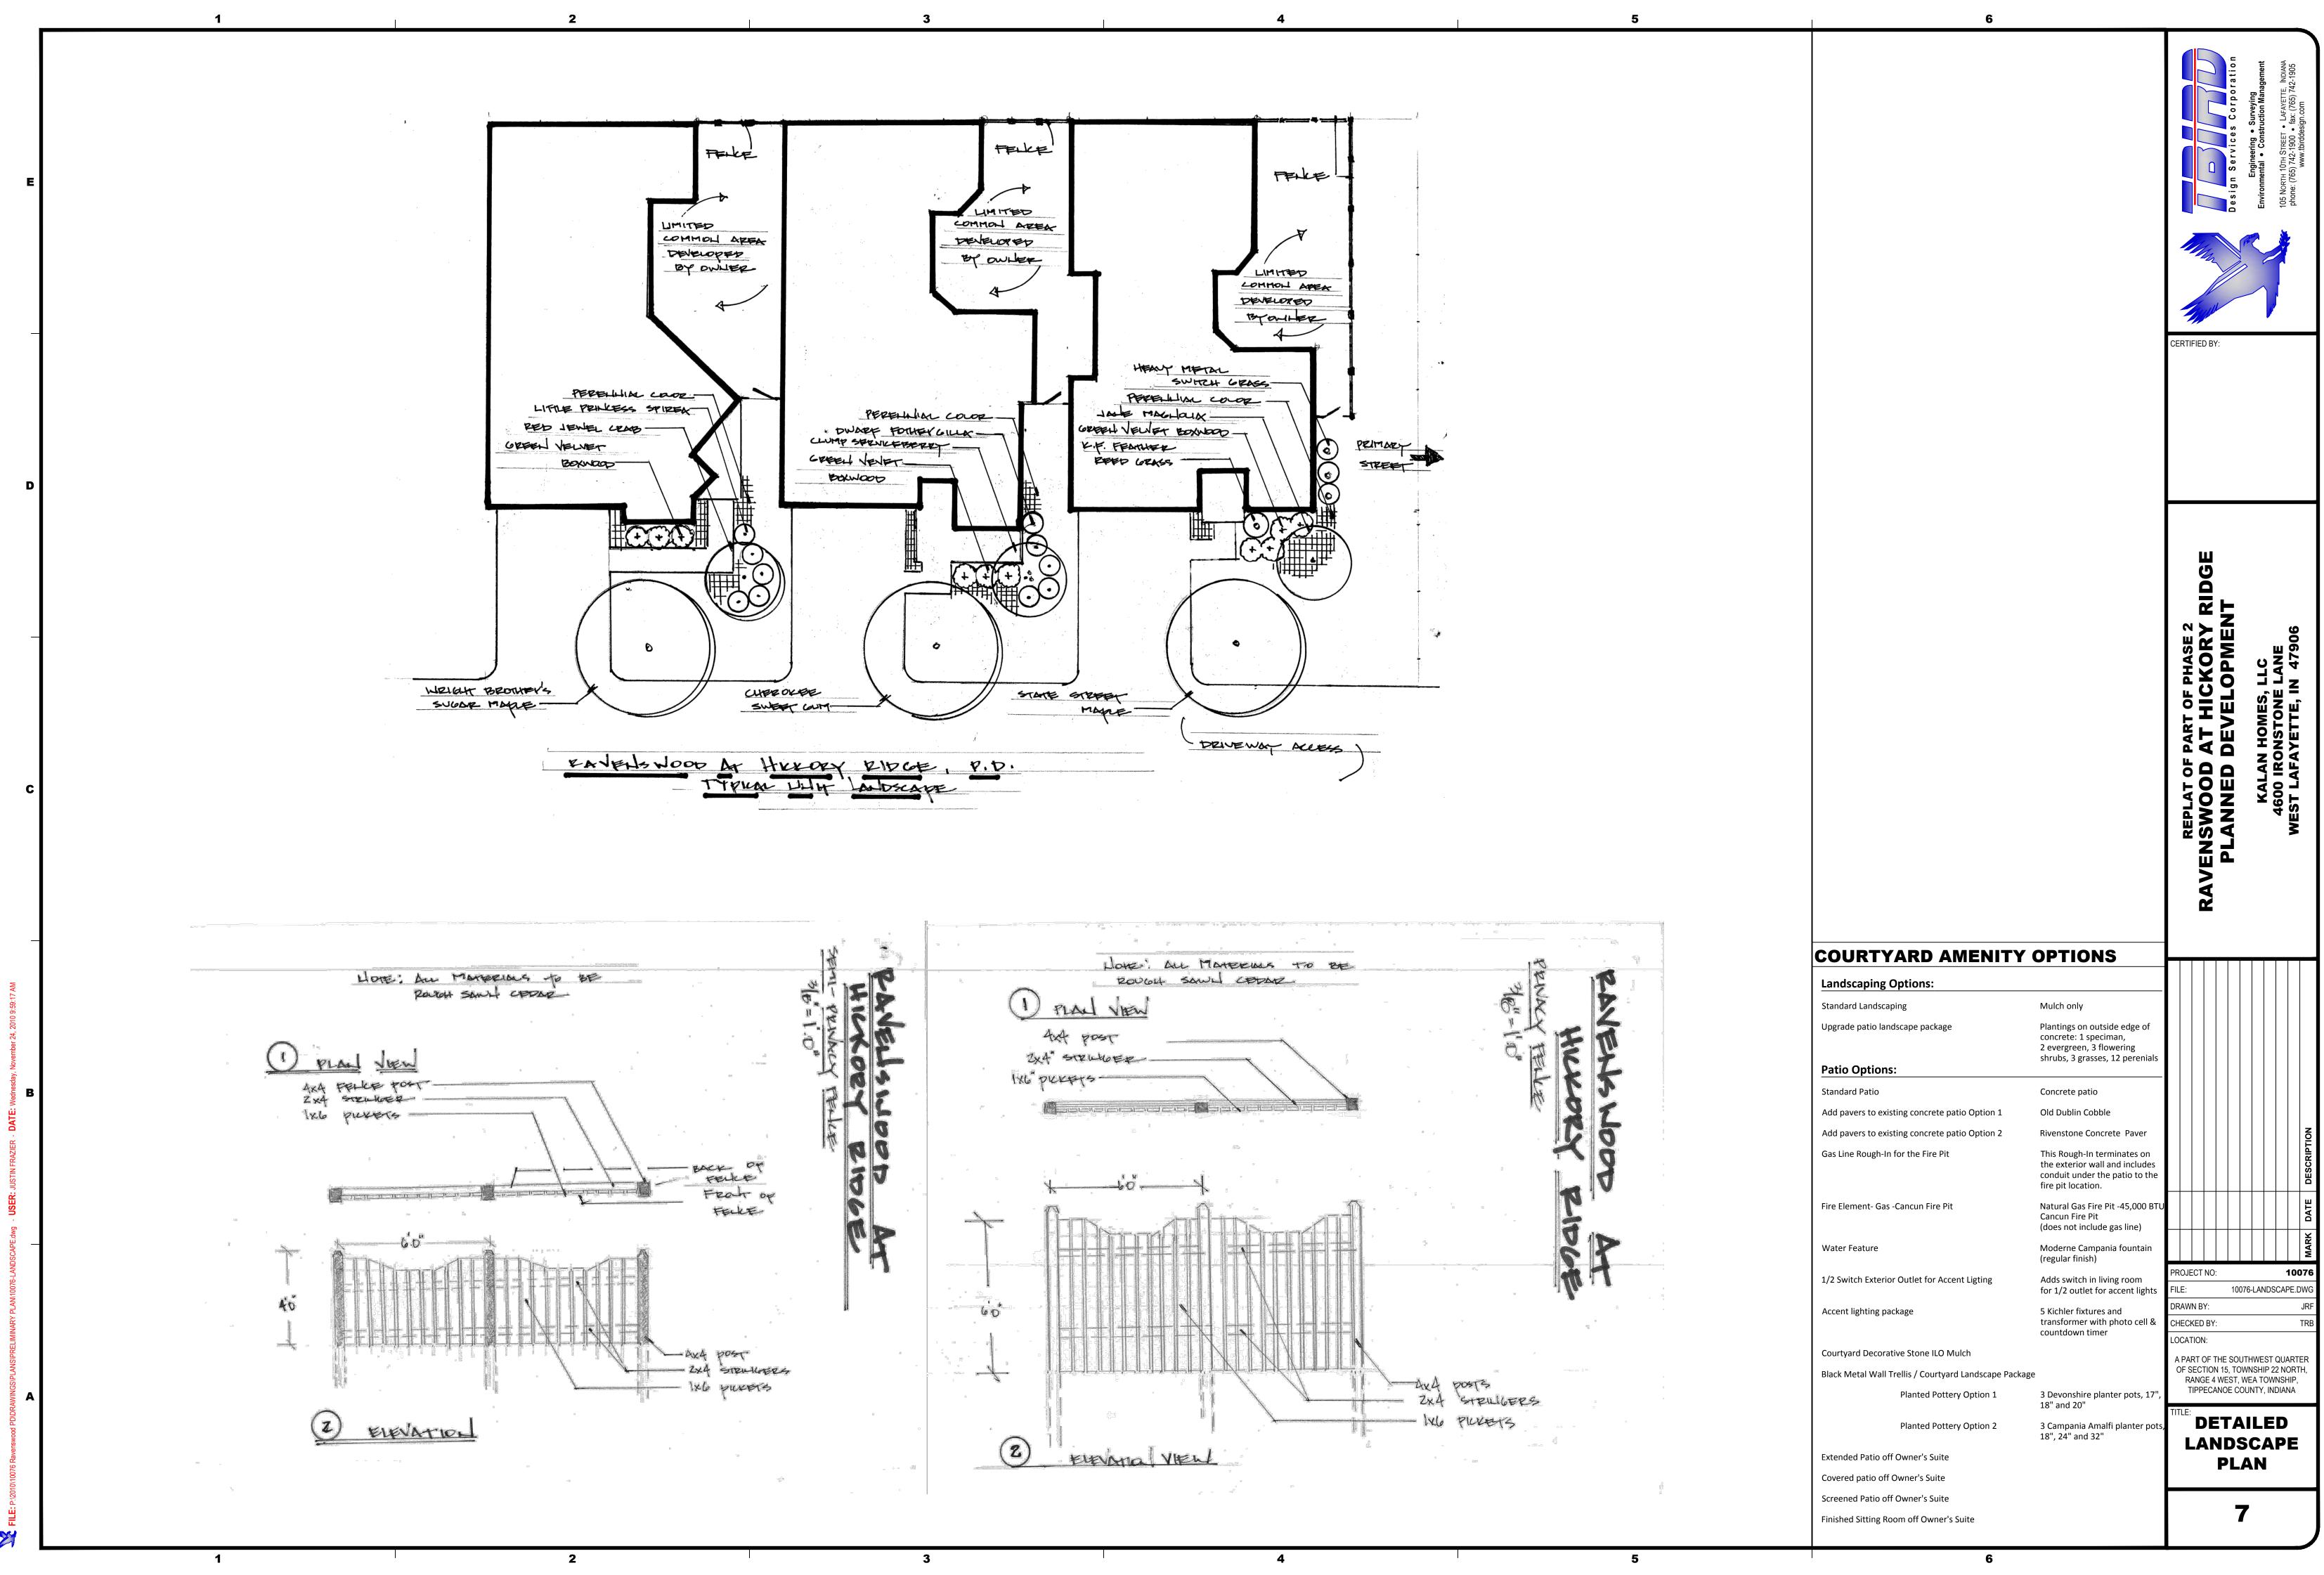

•

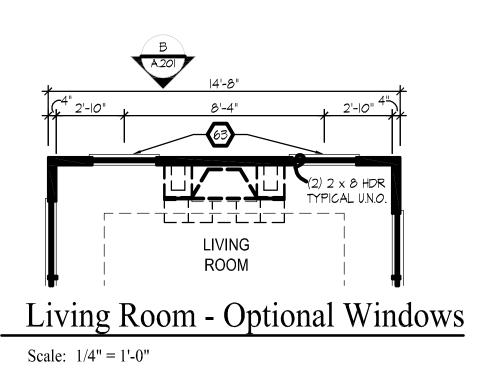

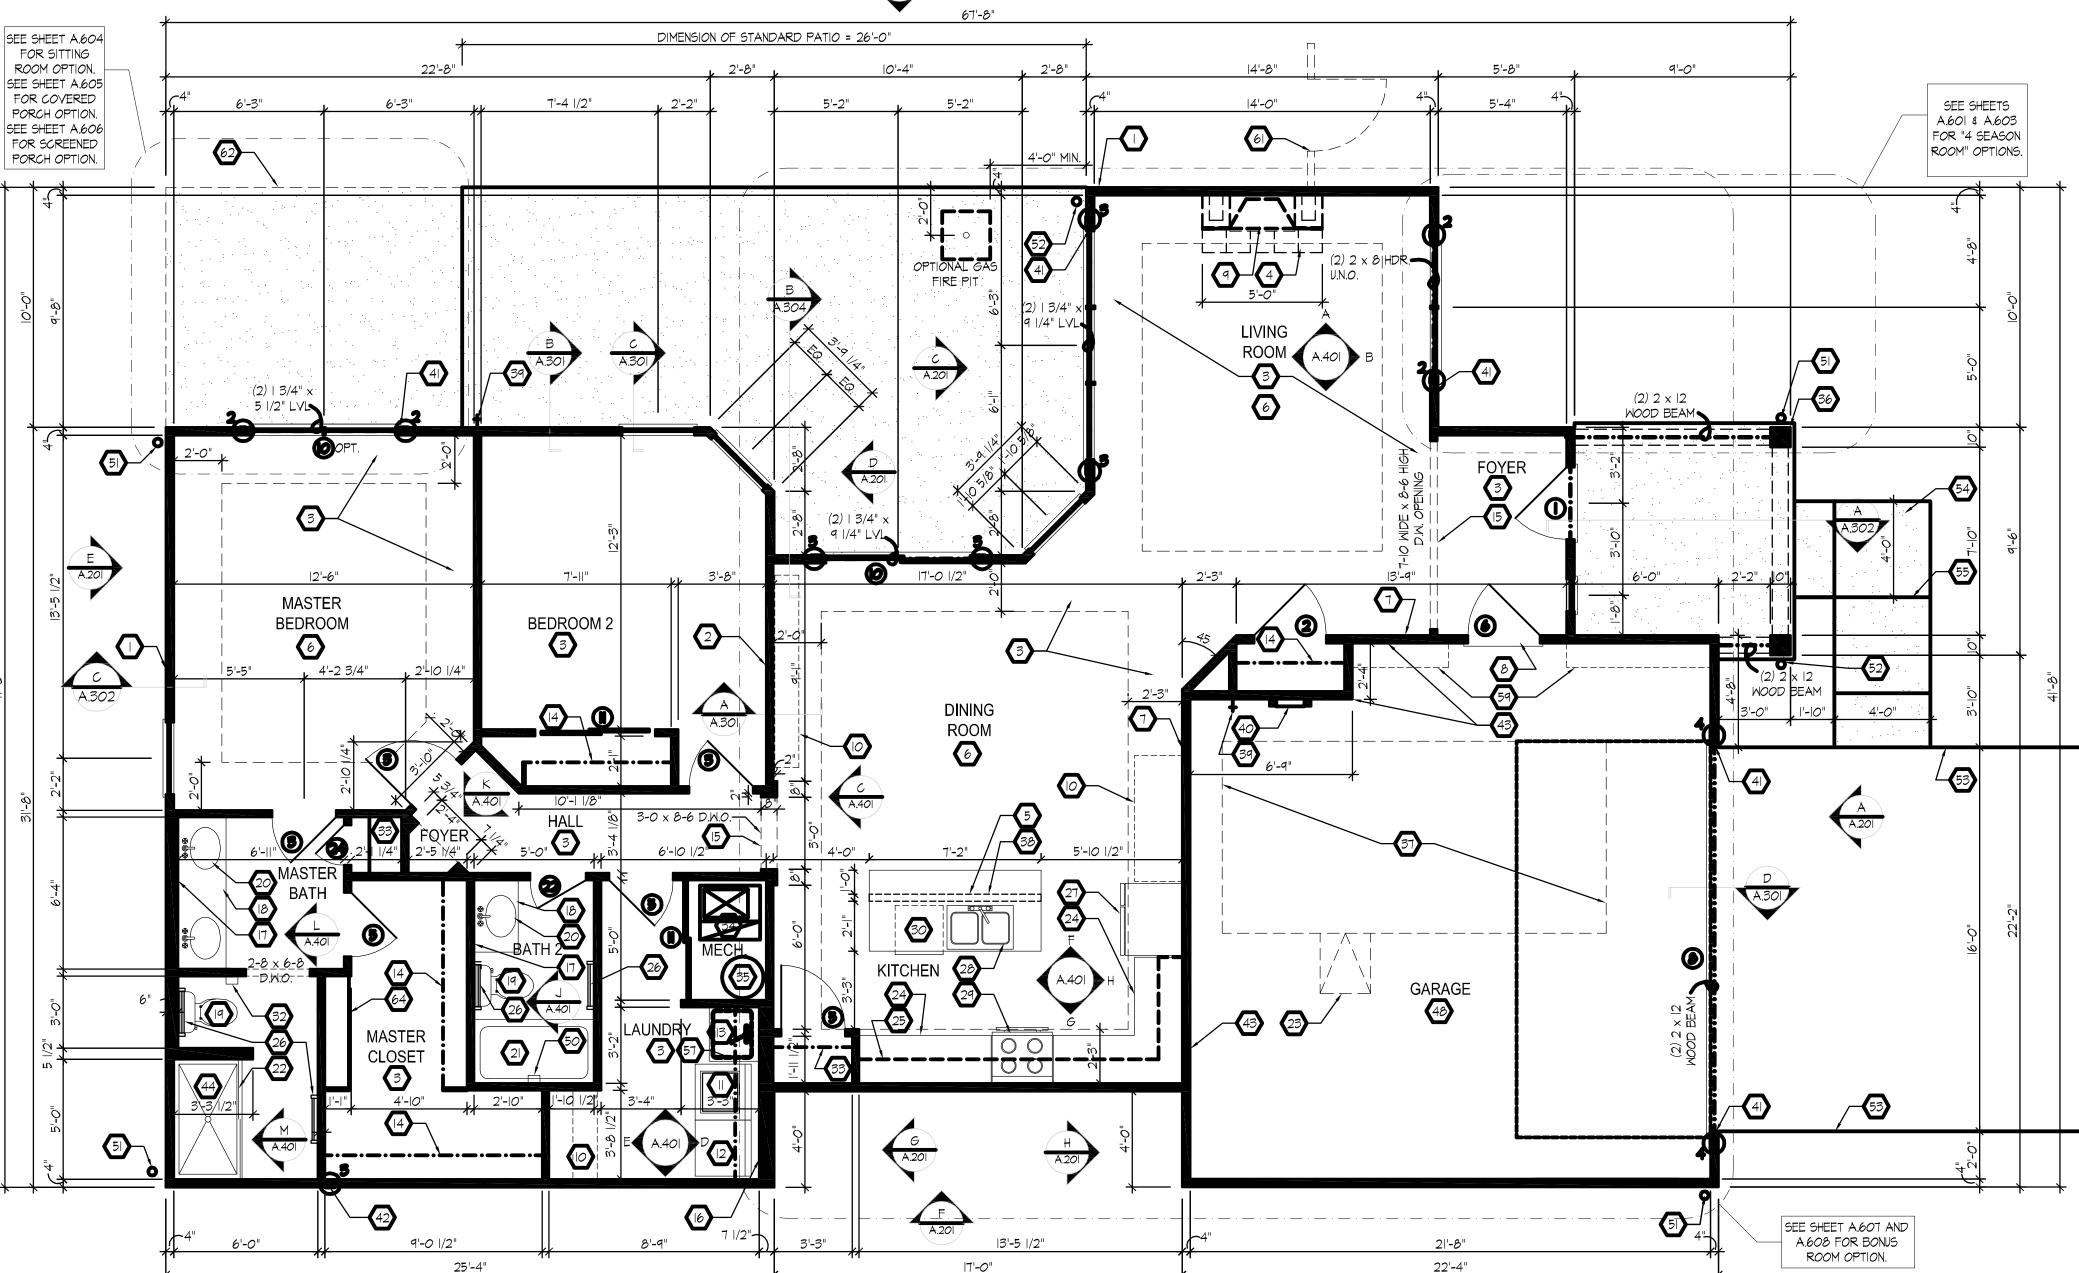


64'-8"

First Floor Plan


Scale: 1/4'' = 1'-0''

THESE ARCHITECTURAL PLANS DEPICT THE GENERAL PLAN FOR CONDOMINIUM BUILDINGS WITHIN THE PROPOSED PLANNED DEVELOPMENT. ADDITIONAL PLANS FOR CONDOMINIUM BUILDINGS MAY BE USED FOR BUILDINGS WITHIN THE PROPOSED PLANNED DEVELOPMENT PROVIDED THAT THEY HAVE AT LEAST A 2 CAR GARAGE AND DO NOT EXCEED THE LENGTH AND WIDTH OF THE LARGEST UNIT SHOWN HEREIN.

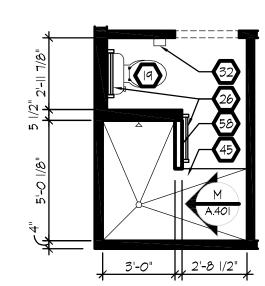

Master Bath - Optional Walk-in Shower

Scale: 1/4'' = 1'-0''

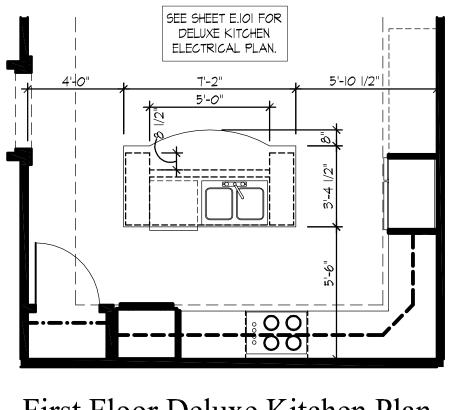

First Floor Deluxe Kitchen Plan

Scale: 1/4'' = 1'-0''

11. LINE OF BREAK OF SLOPED DRYWALL CEILING - FOLLOW BOTTOM CHORD OF ROOF TRUSSES OR RAFTERS

- 72. SLOPED CEILING AREA ABOVE.
- 73. ACCESS PANEL 22 I/2" x 30"- 6" MIN. A.F.F.
- 14. UNDER THE COUNTER REFRIGERATOR LOCATION.
- 75. FLAT DRYWALL CEILING @ 7'-O" A.F.F..
- 76. HALF WALL @ 36" A.F.F. WITH I X 6 HARDWOOD CAP.
- 77. SINGLE CLOSET ROD & SHELF (48" A.F.F.) VINYL COATED WIRE WITH STANDARD SPACING.
- 78. 2×4 STUD KNEE WALL RUN FROM FLOOR STRUCTURE BELOW TO UNDERSIDE OF ROOF FRAMING.
- 79. 3" DIAMETER STANDARD STEEL PIPE COLUMN WITH I/2" CAP PLATE AND I/2" x 4" x 6" BASE PLATE.
- 80. FULL HEIGHT PANTRY CABINET SEE INTERIOR ELEVATIONS.
- 81. DASHED LINE INDICATES BEAM SEE BONUS ROOM GARAGE WALL SECTION.
- 82. LINE INDICATES EXPOSED FOUNDATION STEM WALL.

GENERAL NOTES

ORIENTATIONS.

- I. EXTERIOR WALL DIMENSIONS INCLUDE THICKNESS OF SHEATHING. 2. REFER TO SITE LAYOUT PLAN FOR BUILDING LOCATIONS AND
- 3. DOORS NOT OTHERWISE DIMENSIONED SHALL BE LOCATED WITH ROUGH OPENING 3" FROM INTERSECTING WALLS.

IRST FLOOR UNIT PLANS ONLY)

- (ALL NOTES NOT APPLICABLE TO ALL SHEETS) I. EXTERIOR STUD WALL - 2 X 4 WOOD STUDS AT 16" O.C. WITH 1/2" DRYWALL ON ALL INTERIOR SURFACES AND 1/16"
 - O.S.B. SHEATHING ON EXTERIOR SURFACES TYPICAL.
- 2. INTERIOR STUD WALL 2 X 4 WOOD STUDS AT 16" O.C. WITH 1/2" DRYWALL ON ALL FINISHED SURFACES TYPICAL.

3. FLAT DRYWALL CEILING @ 9'-0" A.F.F. - TYPICAL UNLESS NOTED OTHERWISE.

- 4. 12" DEEP CERAMIC TILE HEARTH EXTENSION CENTERED ON FIREBOX. SEE FLOOR PLAN FOR WIDTH.
- 5. ISLAND BASE CABINETS & COUNTERTOP FINISH ALL EDGES OF CABINETS & COUNTERTOP.
- 6. TRAY CEILING @ 10'-0" A.F.F.
- 7. PROVIDE FIBERGLASS BATT INSULATION IN GARAGE WALLS COMMON TO LIVING SPACE.
- 8. MAINTAIN 4" MINIMUM ELEVATION CHANGE BETWEEN GARAGE FLOOR & FINISHED FIRST FLOOR.
- 9. (OPTIONAL) PREFABRICATED VENT FREE METAL FIREBOX UNIT MAJESTIC MODEL 32VFSC, PROVIDE GAS LINE, GAS LOG SET AND SCREEN - ROUGH OPENING 32 1/2" WIDE X 30 1/4" HIGH X 12 1/4" DEEP.
- IO. OPTIONAL CABINETS SEE INTERIOR ELEVATIONS.
- II. WASHER LOCATION PROVIDE WASHER BOX ON BACK WALL. WASHER ALWAYS LOCATED LEFT OF DRYER.
- 12. DRYER LOCATION DRYER VENT IN WALL.
- 13. OPTIONAL UTILITY SINK AND FAUCET INSTALL ROUGH-IN PLUMING ONLY.
- 14. SINGLE CLOSET ROD \$ SHELF (67 1/2" A.F.F.) VINYL COATED WIRE WITH STANDARD SPACING.
- 15. ARCHED OPENING. SPRING POINT @ 7'-8" A.F.F. TOP OF ARCH 8'-6" ABOVE SPRING POINT.
- 16. LOCATION OF DOUBLE 2 X 4 STUD WALL.
- 17. FRAMELESS MIRROR LOCATION 42" HIGH x 2" SHORTER THAN VANITY TOP (I" EACH SIDE) SET BOTTOM OF MIRROR AT TOP OF BACKSPLASH.
- 18. VANITY BASE AND COUNTERTOP 31 1/2" A.F.F.
- 19. TOILET & SEAT.
- 20. SELF-RIMMING COUNTER LAVATORY AND FAUCET.
- 21. 32" X 60" STANDARD TUB/SHOWER & FAUCET WITH CERAMIC TILE SURROUND.
- 22. TEMPERED GLASS SHOWER ENCLOSURE AND DOOR.

23. 25 1/2" x 54" OPTIONAL PULL DOWN STAIR LOCATED BETWEEN TRUSSES ABOVE. DRYWALL ON STAIR SHALL BE MOUNTED WITH SCREWS INTO THE TOP & BOTTOM DOOR CROSS SUPPORTS WITH THE CENTER GLUED LEAVING NO SCREWS EXPOSED.

- 24. BASE CABINETS AND COUNTERTOP.
- 25. LINE OF WALL CABINETS ABOVE.
- 26. 24" LONG TOWEL BAR 54" A.F.F. (58" A.F.F. ABOVE TOILET).
- 27. REFRIGERATOR LOCATION.
- 28. DOUBLE BOWL SINK AND FAUCET.
- 29. RANGE LOCATION. 30. DISHWASHER LOCATION.
- 31. 10" X 10" BUILT-UP COLUMN TYPICAL. SEE DETAIL D, SHEET A.304 FOR MORE INFORMATION.
- 32. TOILET PAPER DISPENSER.
- 33. (4) 16" DEEP WIRE SHELVES (29", 42", 55", 68" A.F.F.) STANDARD SPACING. TYPICAL AT LINEN CLOSETS AND
- PANTRIES, UNLESS NOTED OTHERWISE.
- 34. FURNACE LOCATION. 35. WATER HEATER LOCATION - WITH PAN.
- 36. IO" X IO" BUILT-UP COLUMN TYPICAL. SEE DETAIL F, SHEET A.304 FOR MORE INFORMATION.
- 31. $16'-0" \times 8"-0"$ OPTIONAL ATTIC STORAGE ABOVE PROVIDE 3/4" APA RATED SUB-FLOORING ON BOTTOM CHORD
- 38. I/2 WALL TO UNDERSIDE OF BAR COUNTERTOP.
- 39. HOSE BIBB LOCATION.
- 40. SURFACE MOUNTED ELECTRIC PANEL LOCATION.
- 41. PROVIDE (2) JACKS UNDER ALL HEADERS IN OPENINGS OVER 60" WIDE TYPICAL.
- 42. INDICATES MULTIPLE STUD COLUMN IN WALL TYPICAL AT BEARING OF ALL WOOD BEAMS, GIRDER TRUSSES
- UNLESS NOTED OTHERWISE. SEE PLAN FOR NUMBER OF STUDS REQUIRED.
- 43. MINIMUM I/2" DRYWALL ON GARAGE SIDE.
- 44. 32" X 60" STANDARD SHOWER BASE.
- 45. CUSTOM TILED ROLL-IN SHOWER BASE SEE PLAN FOR SIZE.
- 46. WOOD GUARD RAIL SEE DETAIL K ON SHEET A.304.
- 47. 8" ROUND DORIC COLUMN.
- 48. FLAT DRYWALL CEILING ON UNDERSIDE OF BOTTOM CHORD OF ROOF TRUSSES OR FLOOR JOISTS.
- 49. FLAT DRYWALL CEILING @ 8'-4" A.F.F.
- 50. SOAP DISH 5" HIGH X 7" WIDE.
- 51. DOWNSPOUT LOCATION.
- 52. DOWNSPOUT DISCHARGED INTO BLACK PIPE AND ROUTED UNDER WALKS OR PATIO.
- 53. EDGE OF DRIVEWAY.
- 54. 4" THICK SLAB TYPICAL @ CONCRETE WALKS/PORCHES/PATIOS
- 55. CONTROL JOINTS TYPICAL.
- 56. DASHED LINES INDICATE BOXED BEAM ABOVE.
- 57. 12" DEEP SHELF (60" A.F.F.) VINYL COATED WIRE STANDARD SPACING. 58. SHOWER WALL - 6'-0" A.F.F.
- 59. OPTIONAL GARAGE SHELVING.
- 60. OPTIONAL DESK.
- 61. COURTYARD GATE AND FENCE LOCATION.
- 62. DASHED LINE INDICATES OPTIONAL PATIO SECTION.
- 63. OPTIONAL WINDOWS.

64. (4) 12" DEEP WIRE SHELVES (29", 42", 55", 68" A.F.F.) - STANDARD SPACING. TYPICAL AT LINEN CLOSETS AND

- PANTRIES, UNLESS NOTED OTHERWISE. 65. 32" X 60" SHOWER BASE WITH BUILT-IN SEAT.
- 66. HARDBOARD TREADS AND RISERS.
- 67. WOOD HANDRAIL 34" ABOVE STAIR TREADS. RETURN ENDS TO WALL OR NEWEL POST.
- 68. SINGLE BOWL SINK AND FAUCET.
- 69. 20" RANGE LOCATION.
- 70. FLAT DRYWALL CEILING @ 8'-0" A.F.F..

HOMES


INFORMATION CONTAINED WITHIN THIS DOCUMENT INCLUDING. BUT NOT LIMITED TO, DESIGN CONCEPTS, ARE PROPERTY OF ARKOR. REPRODUCTION OF THIS INFORMATION IS PROHIBITED WITHOUT WRITTEN CONSENT OF ARKOR.


DRAWN BY: LJS CHK'D BY: AAS PLAN DATE: November 19, 2010


PLOT DATE: November 23, 2010


PROJECT NUMBER: R-10037


> SHEET NUMBER: A.101 D1 - 2010

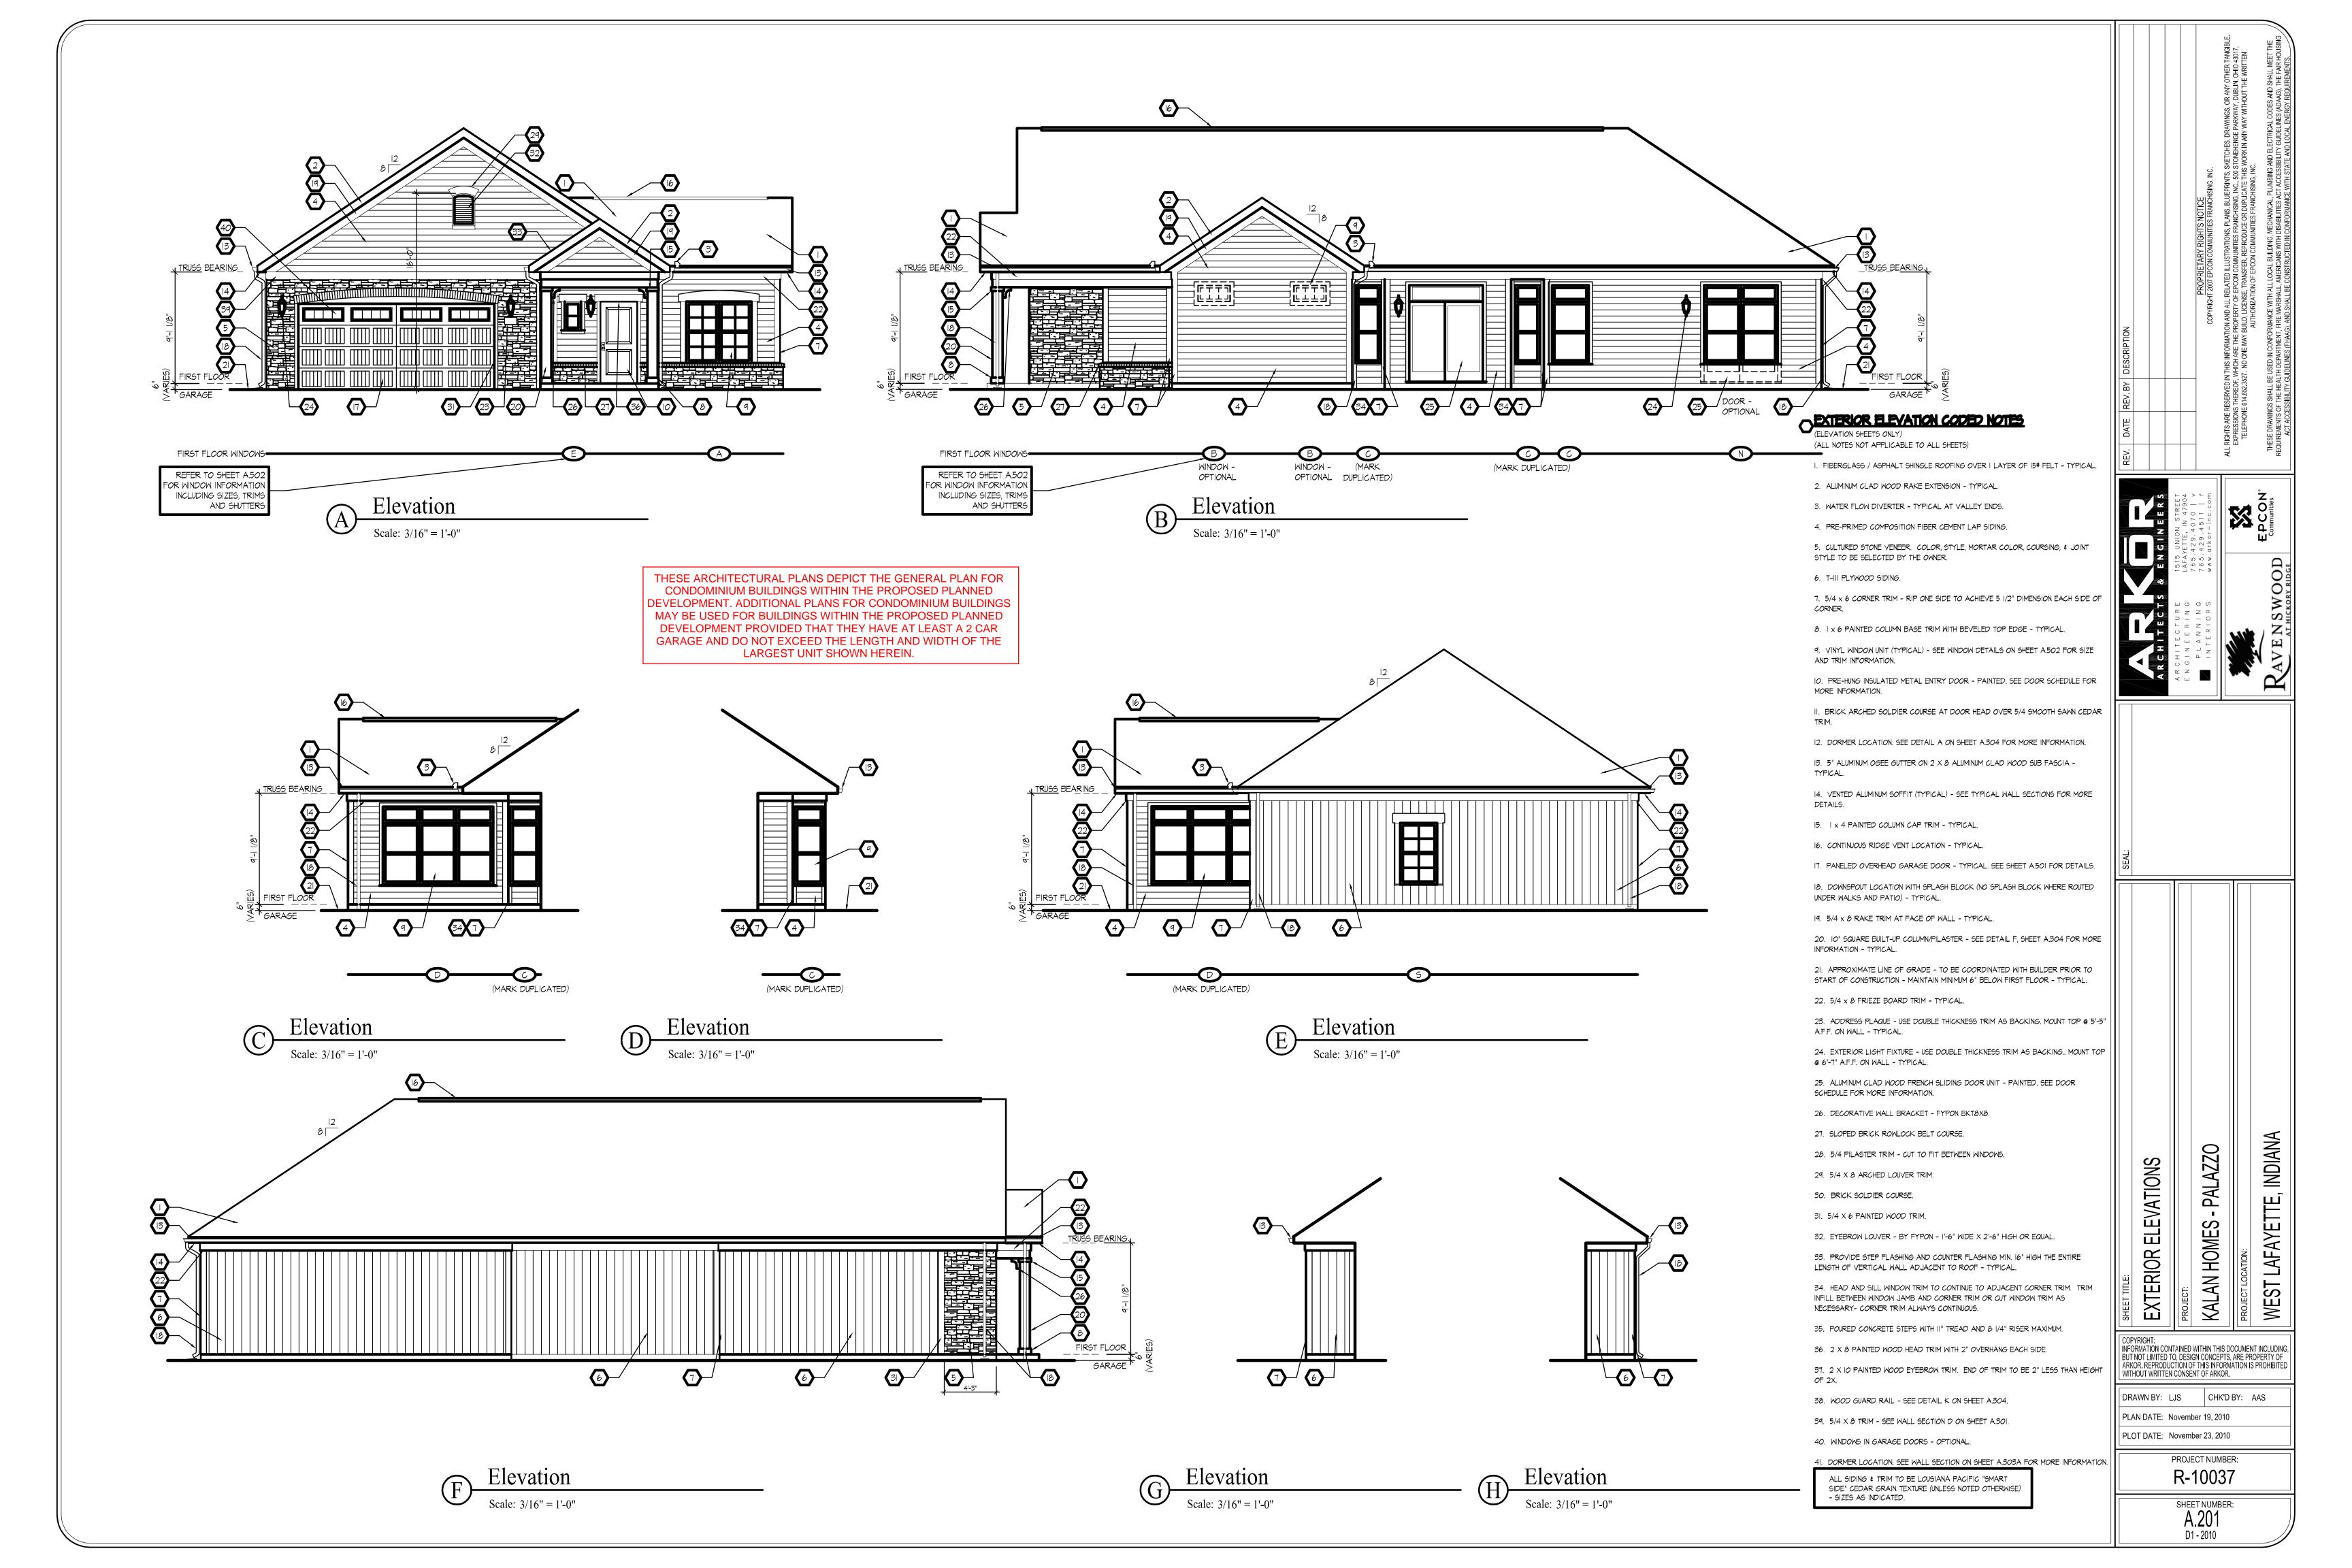

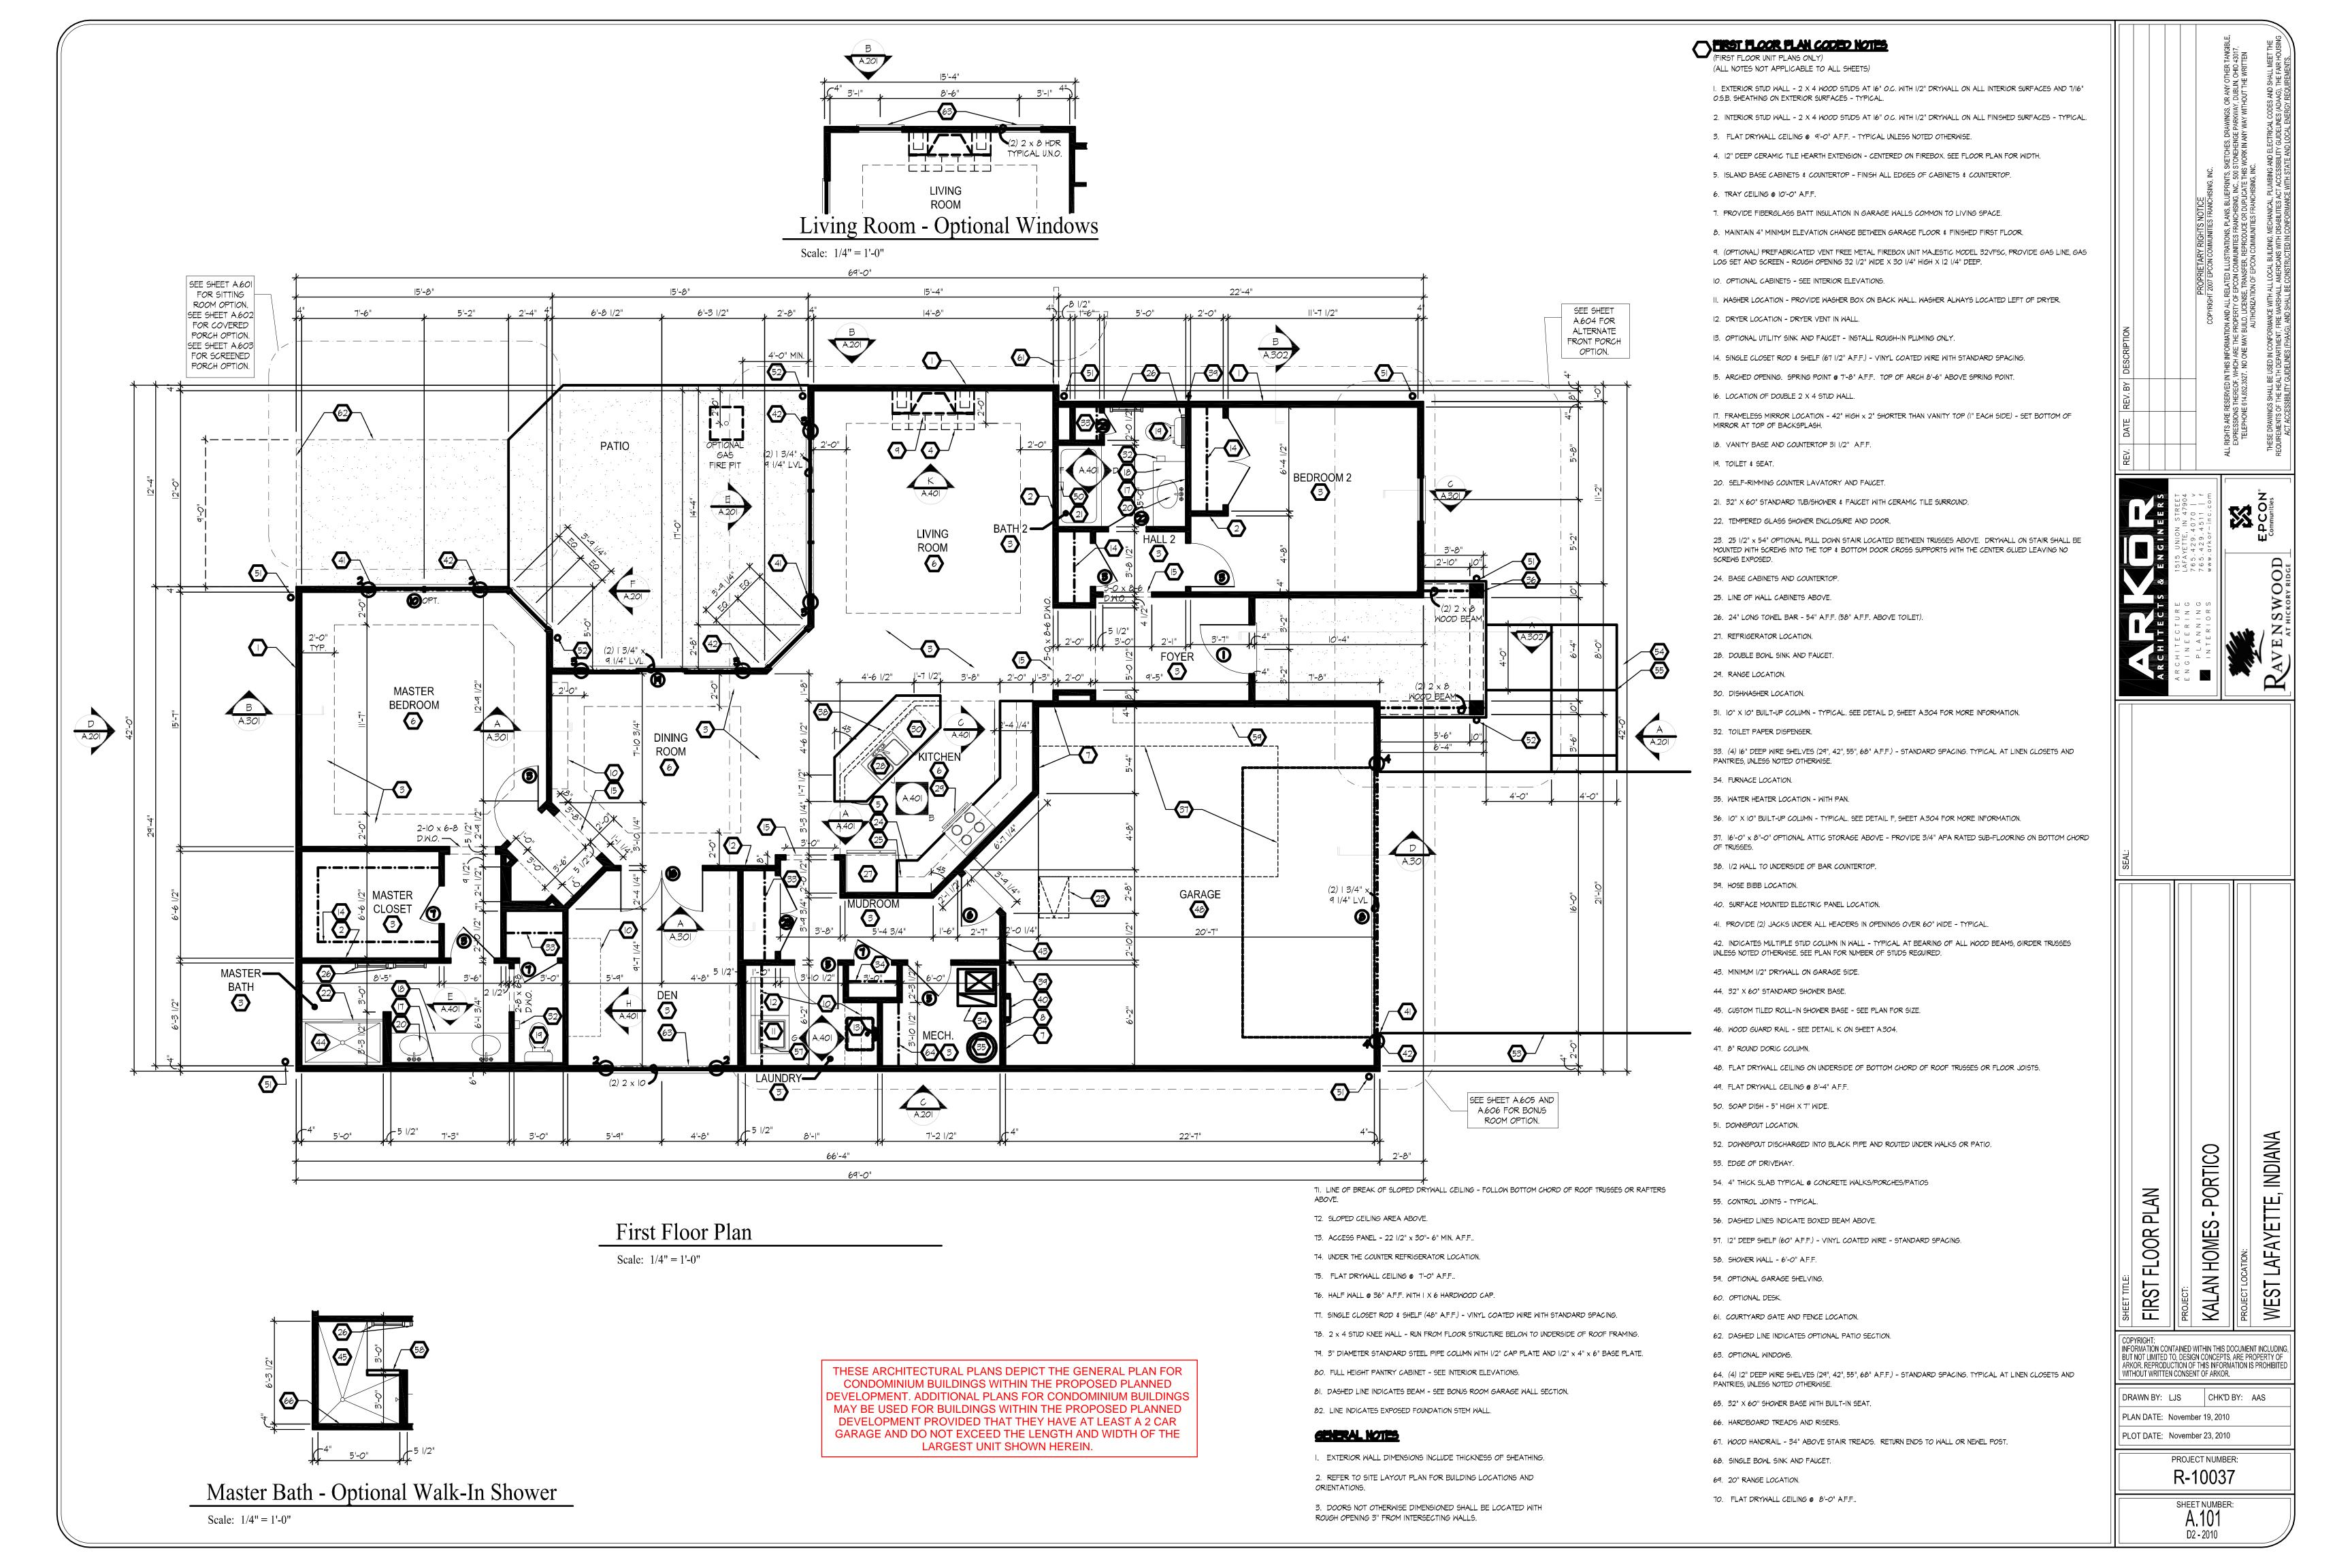

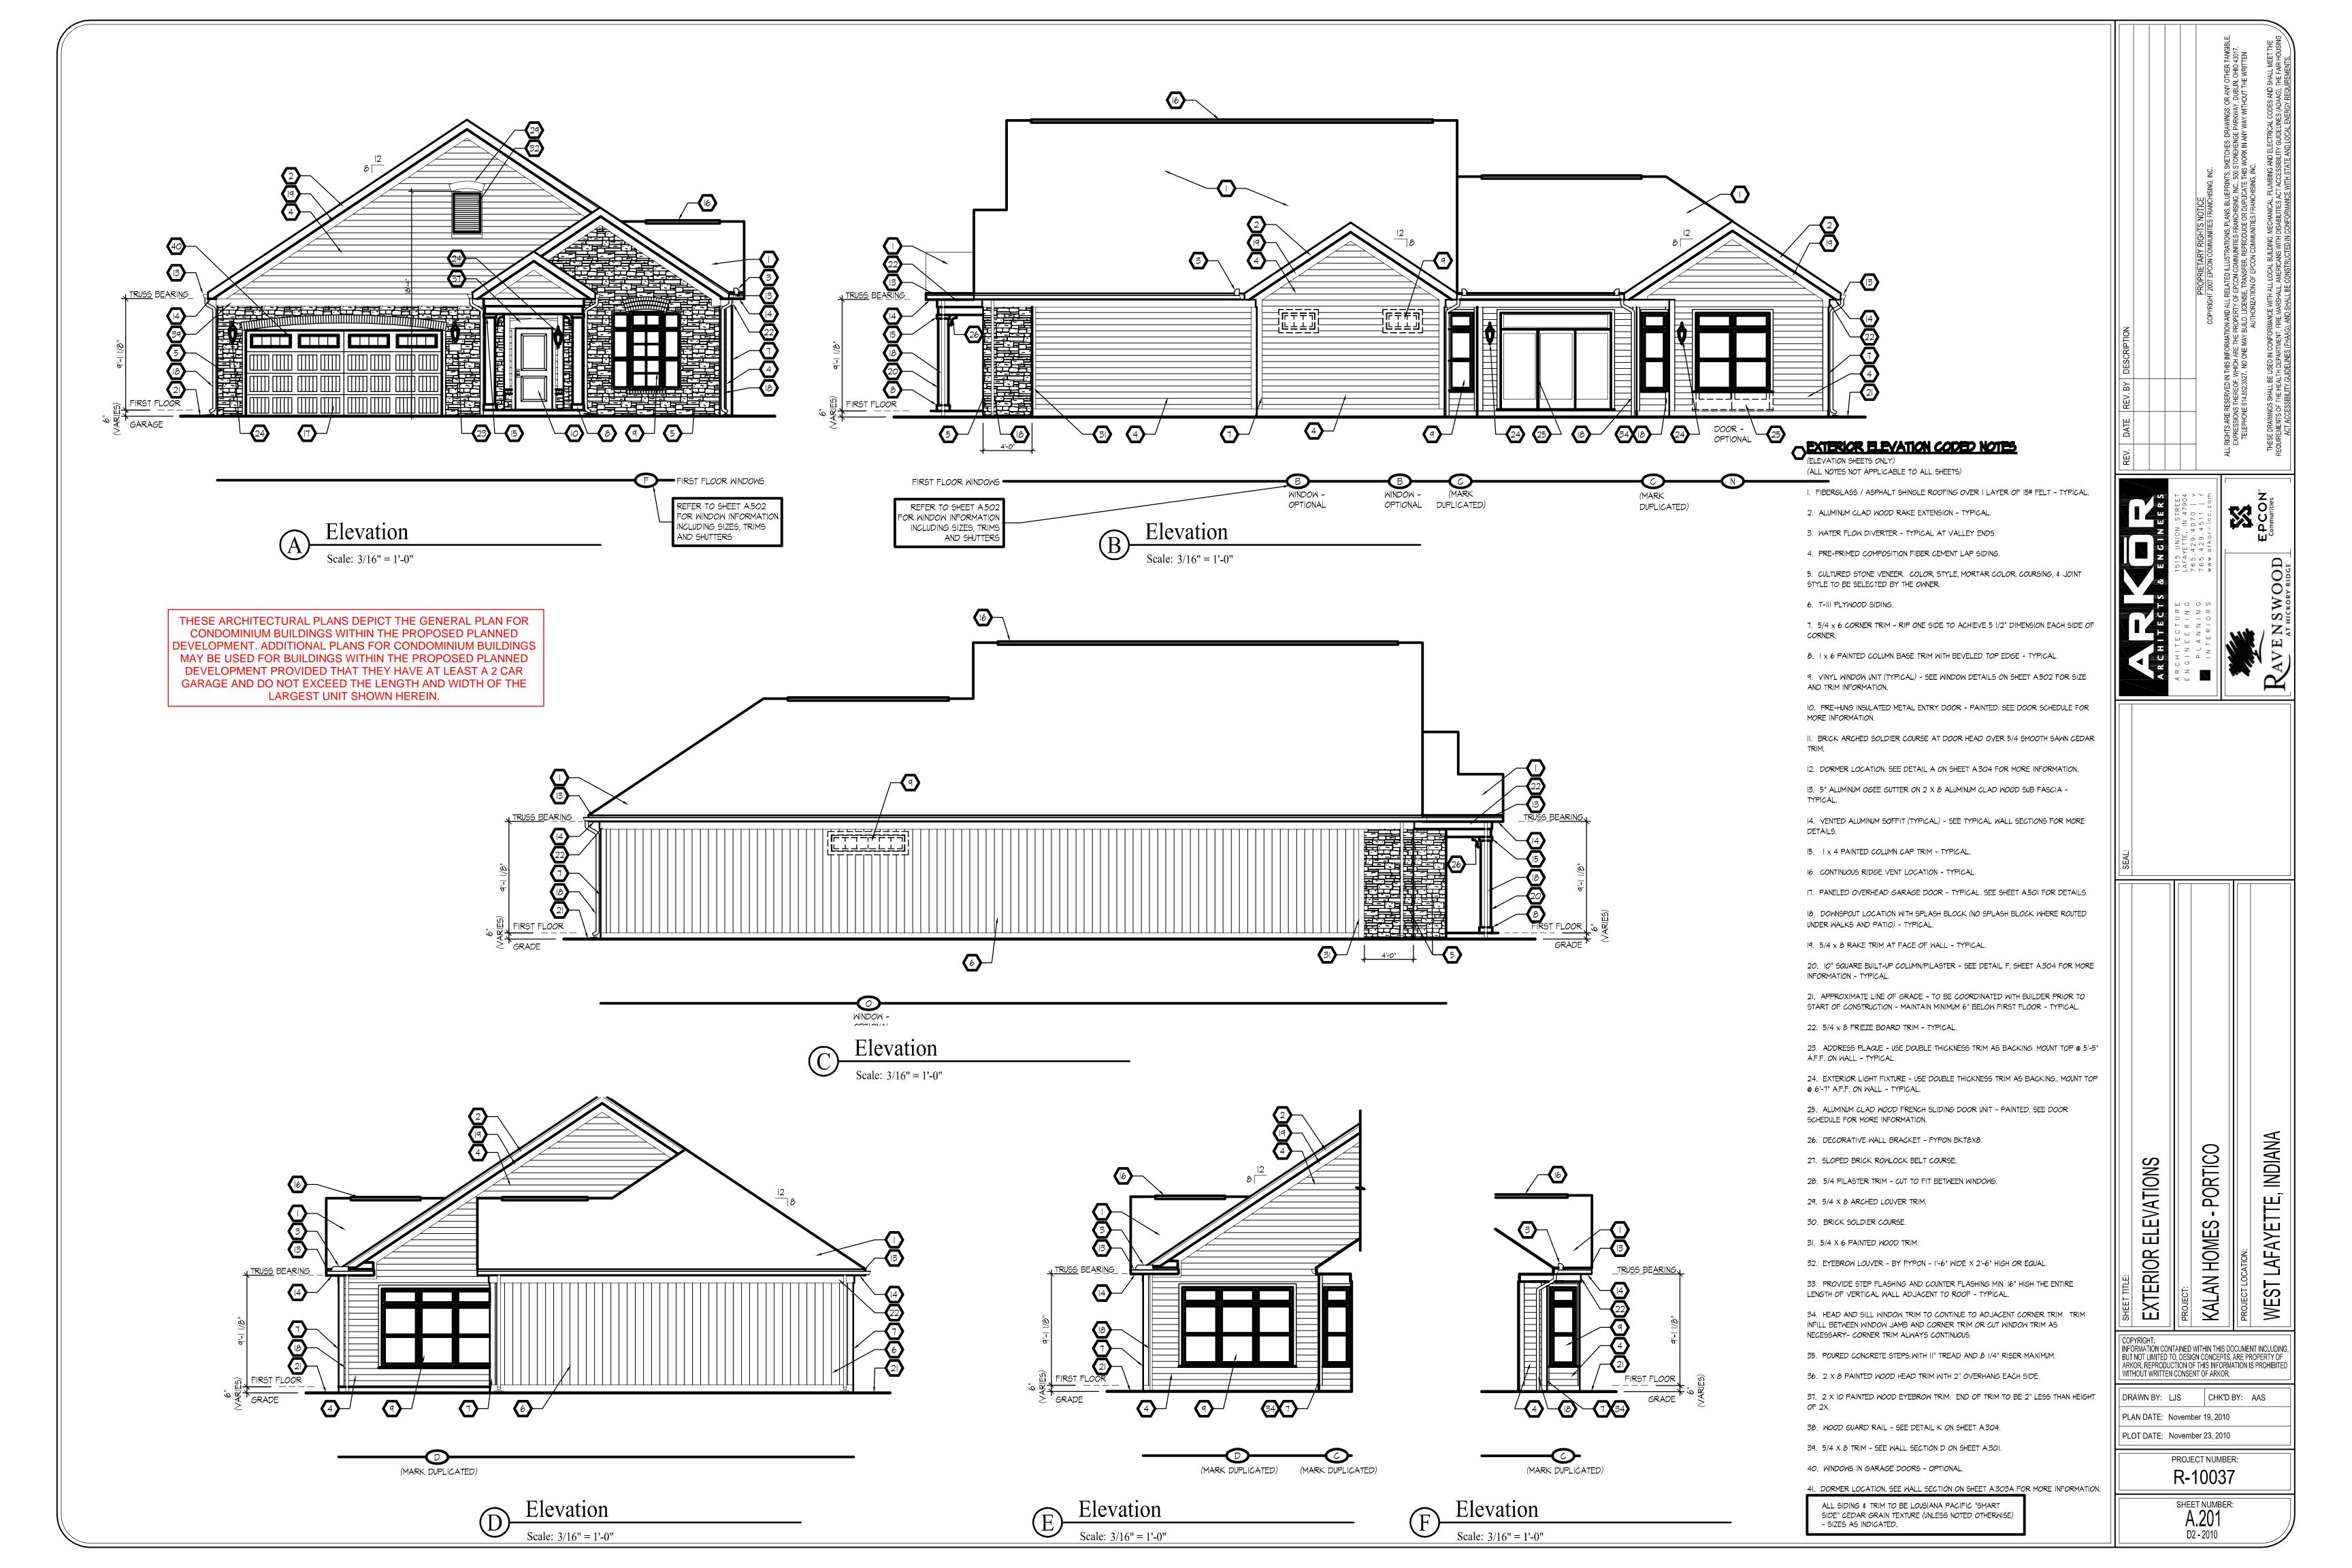


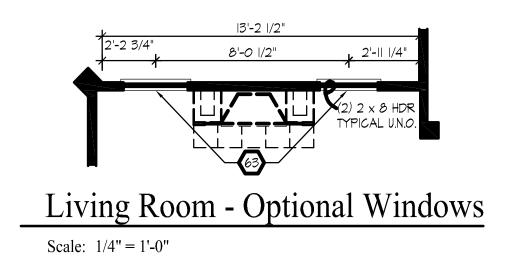

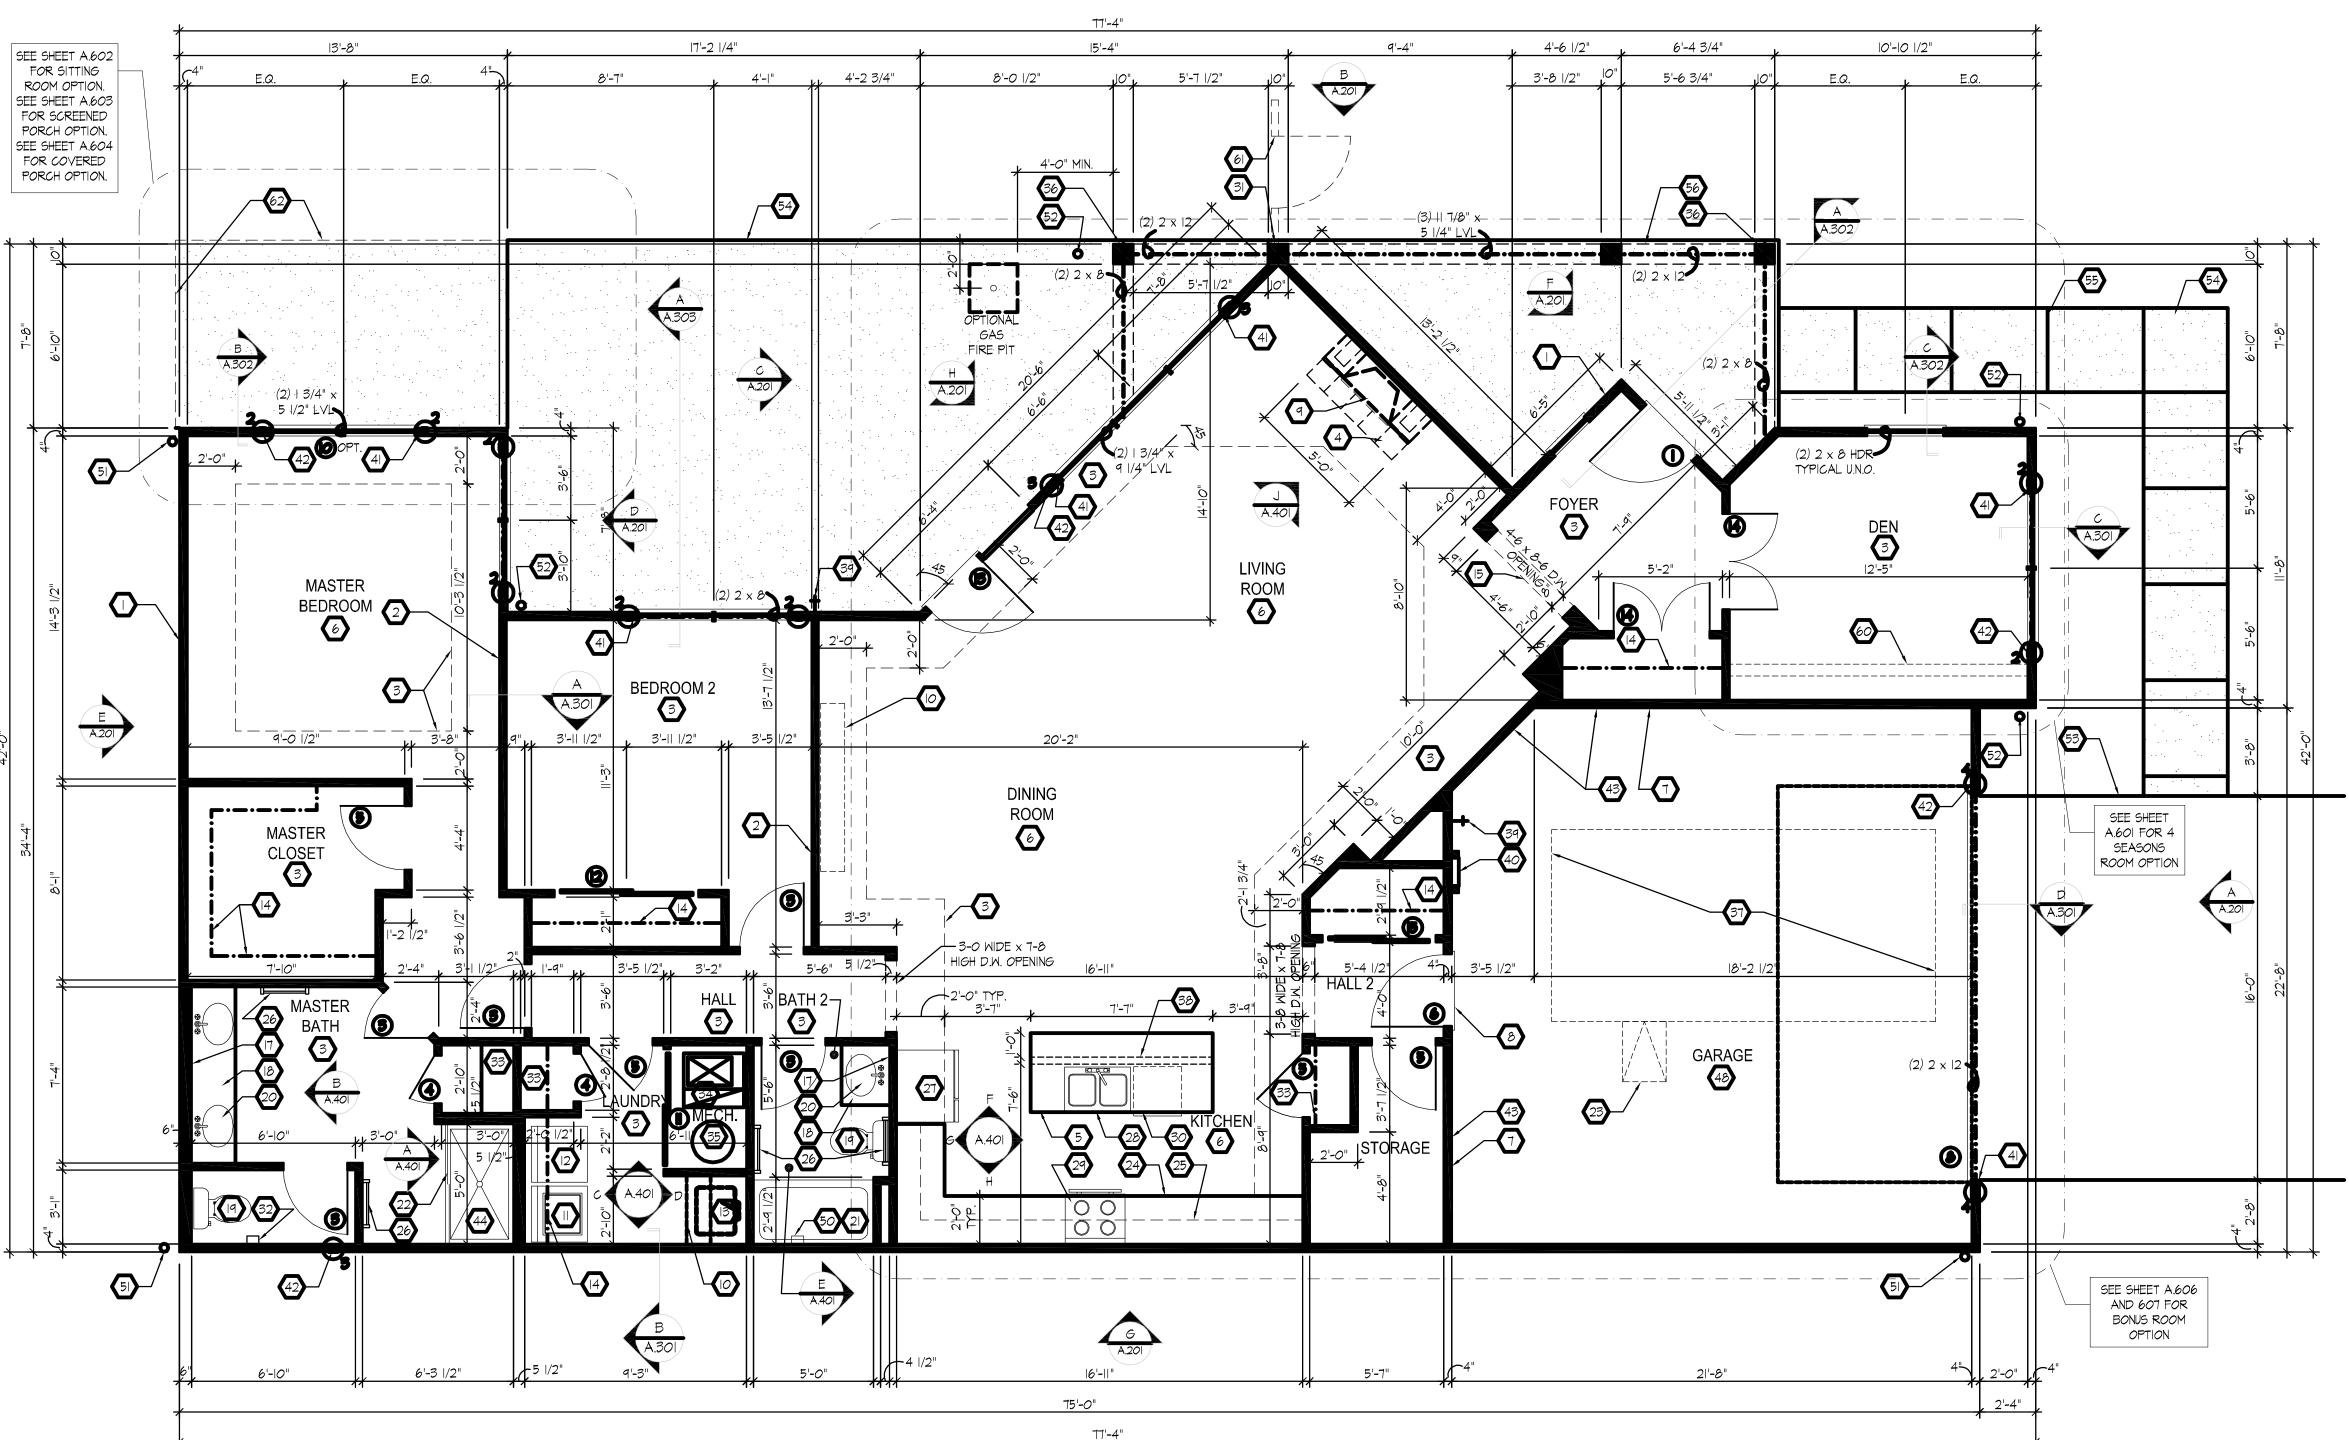

First Floor Plan

Scale: 1/4'' = 1'-0''

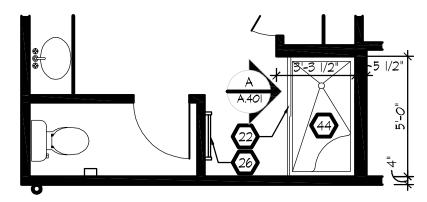

THESE ARCHITECTURAL PLANS DEPICT THE GENERAL PLAN FOR CONDOMINIUM BUILDINGS WITHIN THE PROPOSED PLANNED DEVELOPMENT. ADDITIONAL PLANS FOR CONDOMINIUM BUILDINGS MAY BE USED FOR BUILDINGS WITHIN THE PROPOSED PLANNED DEVELOPMENT PROVIDED THAT THEY HAVE AT LEAST A 2 CAR GARAGE AND DO NOT EXCEED THE LENGTH AND WIDTH OF THE LARGEST UNIT SHOWN HEREIN.

Master Bath - Optional Walk-In Shower

Scale: 1/4'' = 1'-0''

71. LINE OF BREAK OF SLOPED DRYWALL CEILING - FOLLOW BOTTOM CHORD OF ROOF TRUSSES OR RAFTERS

74. UNDER THE COUNTER REFRIGERATOR LOCATION.

77. SINGLE CLOSET ROD & SHELF (48" A.F.F.) - VINYL COATED WIRE WITH STANDARD SPACING.

79. 3" DIAMETER STANDARD STEEL PIPE COLUMN WITH 1/2" CAP PLATE AND 1/2" x 4" x 6" BASE PLATE.

80. FULL HEIGHT PANTRY CABINET - SEE INTERIOR ELEVATIONS.

I. EXTERIOR WALL DIMENSIONS INCLUDE THICKNESS OF SHEATHING. 2. REFER TO SITE LAYOUT PLAN FOR BUILDING LOCATIONS AND

72. SLOPED CEILING AREA ABOVE.

73. ACCESS PANEL - 22 I/2" x 30"- 6" MIN. A.F.F..

75. FLAT DRYWALL CEILING @ 7'-0" A.F.F..

76. HALF WALL @ 36" A.F.F. WITH I X 6 HARDWOOD CAP.

18. 2×4 STUD KNEE WALL - RUN FROM FLOOR STRUCTURE BELOW TO UNDERSIDE OF ROOF FRAMING.

81. DASHED LINE INDICATES BEAM - SEE BONUS ROOM GARAGE WALL SECTION.

82. LINE INDICATES EXPOSED FOUNDATION STEM WALL.

GENERAL NOTES

FIRST FLOOR PLAN CODED NOTES

(ALL NOTES NOT APPLICABLE TO ALL SHEETS) I. EXTERIOR STUD WALL - 2 X 4 WOOD STUDS AT 16" O.C. WITH 1/2" DRYWALL ON ALL INTERIOR SURFACES AND 7/16" O.S.B. SHEATHING ON EXTERIOR SURFACES - TYPICAL.

2. INTERIOR STUD WALL - 2 X 4 WOOD STUDS AT 16" O.C. WITH 1/2" DRYWALL ON ALL FINISHED SURFACES - TYPICAL.

3. FLAT DRYWALL CEILING @ 9'-0" A.F.F. - TYPICAL UNLESS NOTED OTHERWISE.

4. 12" DEEP CERAMIC TILE HEARTH EXTENSION - CENTERED ON FIREBOX. SEE FLOOR PLAN FOR WIDTH.

5. ISLAND BASE CABINETS & COUNTERTOP - FINISH ALL EDGES OF CABINETS & COUNTERTOP.

6. TRAY CEILING @ 10'-0" A.F.F.

7. PROVIDE FIBERGLASS BATT INSULATION IN GARAGE WALLS COMMON TO LIVING SPACE.

8. MAINTAIN 4" MINIMUM ELEVATION CHANGE BETWEEN GARAGE FLOOR & FINISHED FIRST FLOOR.

9. (OPTIONAL) PREFABRICATED VENT FREE METAL FIREBOX UNIT MAJESTIC MODEL 32VFSC, PROVIDE GAS LINE, GAS LOG SET AND SCREEN - ROUGH OPENING 32 1/2" WIDE X 30 1/4" HIGH X 12 1/4" DEEP.

IO. OPTIONAL CABINETS - SEE INTERIOR ELEVATIONS.

II. WASHER LOCATION - PROVIDE WASHER BOX ON BACK WALL. WASHER ALWAYS LOCATED LEFT OF DRYER.

12. DRYER LOCATION - DRYER VENT IN WALL.

13. OPTIONAL UTILITY SINK AND FAUCET - INSTALL ROUGH-IN PLUMING ONLY.

14. SINGLE CLOSET ROD & SHELF (67 1/2" A.F.F.) - VINYL COATED WIRE WITH STANDARD SPACING.

15. ARCHED OPENING. SPRING POINT @ 7'-8" A.F.F. TOP OF ARCH 8'-6" ABOVE SPRING POINT.

16. LOCATION OF DOUBLE 2 X 4 STUD WALL.

IT. FRAMELESS MIRROR LOCATION - 42" HIGH \times 2" SHORTER THAN VANITY TOP (I" EACH SIDE) - SET BOTTOM OF MIRROR AT TOP OF BACKSPLASH.

18. VANITY BASE AND COUNTERTOP 31 1/2" A.F.F.

19. TOILET & SEAT.

20. SELF-RIMMING COUNTER LAVATORY AND FAUCET.

21. 32" X 60" STANDARD TUB/SHOWER & FAUCET WITH CERAMIC TILE SURROUND.

22. TEMPERED GLASS SHOWER ENCLOSURE AND DOOR.

23. 25 1/2" x 54" OPTIONAL PULL DOWN STAIR LOCATED BETWEEN TRUSSES ABOVE. DRYWALL ON STAIR SHALL BE MOUNTED WITH SCREWS INTO THE TOP & BOTTOM DOOR CROSS SUPPORTS WITH THE CENTER GLUED LEAVING NO

24. BASE CABINETS AND COUNTERTOP.

25. LINE OF WALL CABINETS ABOVE.

26. 24" LONG TOWEL BAR - 54" A.F.F. (58" A.F.F. ABOVE TOILET).

27. REFRIGERATOR LOCATION. 28. DOUBLE BOWL SINK AND FAUCET.

29. RANGE LOCATION.

30. DISHWASHER LOCATION.

31. 10" X 10" BUILT-UP COLUMN - TYPICAL. SEE DETAIL D, SHEET A.304 FOR MORE INFORMATION.

32. TOILET PAPER DISPENSER. 33. (4) I6" DEEP WIRE SHELVES (29", 42", 55", 66" A.F.F.) - STANDARD SPACING. TYPICAL AT LINEN CLOSETS AND

PANTRIES, UNLESS NOTED OTHERWISE.

34. FURNACE LOCATION.

35. WATER HEATER LOCATION - WITH PAN. 36. IO" X IO" BUILT-UP COLUMN - TYPICAL. SEE DETAIL F, SHEET A.304 FOR MORE INFORMATION.

37. I6'-O" x 8"-O" OPTIONAL ATTIC STORAGE ABOVE - PROVIDE 3/4" APA RATED SUB-FLOORING ON BOTTOM CHORD

OF TRUSSES.

38. I/2 WALL TO UNDERSIDE OF BAR COUNTERTOP. 39. HOSE BIBB LOCATION.

40. SURFACE MOUNTED ELECTRIC PANEL LOCATION.

41. PROVIDE (2) JACKS UNDER ALL HEADERS IN OPENINGS OVER 60" WIDE - TYPICAL.

42. INDICATES MULTIPLE STUD COLUMN IN WALL - TYPICAL AT BEARING OF ALL WOOD BEAMS, GIRDER TRUSSES

UNLESS NOTED OTHERWISE. SEE PLAN FOR NUMBER OF STUDS REQUIRED.

43. MINIMUM I/2" DRYWALL ON GARAGE SIDE.

44. 32" X 60" STANDARD SHOWER BASE.

45. CUSTOM TILED ROLL-IN SHOWER BASE - SEE PLAN FOR SIZE.

46. WOOD GUARD RAIL - SEE DETAIL K ON SHEET A.304.

47. 8" ROUND DORIC COLUMN.

48. FLAT DRYWALL CEILING ON UNDERSIDE OF BOTTOM CHORD OF ROOF TRUSSES OR FLOOR JOISTS.

49. FLAT DRYWALL CEILING @ 8'-4" A.F.F. 50. SOAP DISH - 5" HIGH X 7" WIDE.

51. DOWNSPOUT LOCATION.

52. DOWNSPOUT DISCHARGED INTO BLACK PIPE AND ROUTED UNDER WALKS OR PATIO.

54. 4" THICK SLAB TYPICAL @ CONCRETE WALKS/PORCHES/PATIOS

55. CONTROL JOINTS - TYPICAL.

56. DASHED LINES INDICATE BOXED BEAM ABOVE.

57. 12" DEEP SHELF (60" A.F.F.) - VINYL COATED WIRE - STANDARD SPACING.

58. SHOWER WALL - 6'-0" A.F.F.

59. OPTIONAL GARAGE SHELVING.

60. OPTIONAL DESK.

61. COURTYARD GATE AND FENCE LOCATION.

62. DASHED LINE INDICATES OPTIONAL PATIO SECTION.

63. OPTIONAL WINDOWS.

64. (4) 12" DEEP WIRE SHELVES (29", 42", 55", 68" A.F.F.) - STANDARD SPACING. TYPICAL AT LINEN CLOSETS AND PANTRIES, UNLESS NOTED OTHERWISE.

65. 32" X 60" SHOWER BASE WITH BUILT-IN SEAT.

66. HARDBOARD TREADS AND RISERS.

67. WOOD HANDRAIL - 34" ABOVE STAIR TREADS. RETURN ENDS TO WALL OR NEWEL POST.

68. SINGLE BOWL SINK AND FAUCET.

69. 20" RANGE LOCATION.

70. FLAT DRYWALL CEILING @ 8'-0" A.F.F..

INFORMATION CONTAINED WITHIN THIS DOCUMENT INCLUDING. BUT NOT LIMITED TO, DESIGN CONCEPTS, ARE PROPERTY OF ARKOR. REPRODUCTION OF THIS INFORMATION IS PROHIBITED WITHOUT WRITTEN CONSENT OF ARKOR. DRAWN BY: LJS | CHK'D BY: AAS

> PROJECT NUMBER: R-10037

PLAN DATE: November 19, 2010

PLOT DATE: November 23, 2010

SHEET NUMBER: A.101 D3 - 2010

